LEGAL DESCRIPTION

BLOCK A DISTRICT LOT 8073 GROUP 1 NEW WESTMINSTER DISTRICT EXCEPT: PLAN EPP277

BENCHMARK

ELEVATIONS ARE CGVD28 ORTHOMETRIC DERIVED USING GNSS OBSERVATIONS CONVERTED USING THE HTv2 GEOID MODEL.


WHISTLER DEVELOPMENT CORPORATION

CHEAKAMUS CROSSING NEIGHBOURHOOD EXPANSION WHISTLER, BC

BUILDING PERMIT SUBMISSION LOT 2A - 1400 MOUNT FEE ROAD




PROFESSIONAL ENGINEERS & LAND DEVELOPMENT CONSULTANTS - 212 -828 HARBOURSIDE DRIVE, NORTH VANCOUVER, BRITISH COLUMBIA - PH: 604.983.0458 FAX: 604.983.0459

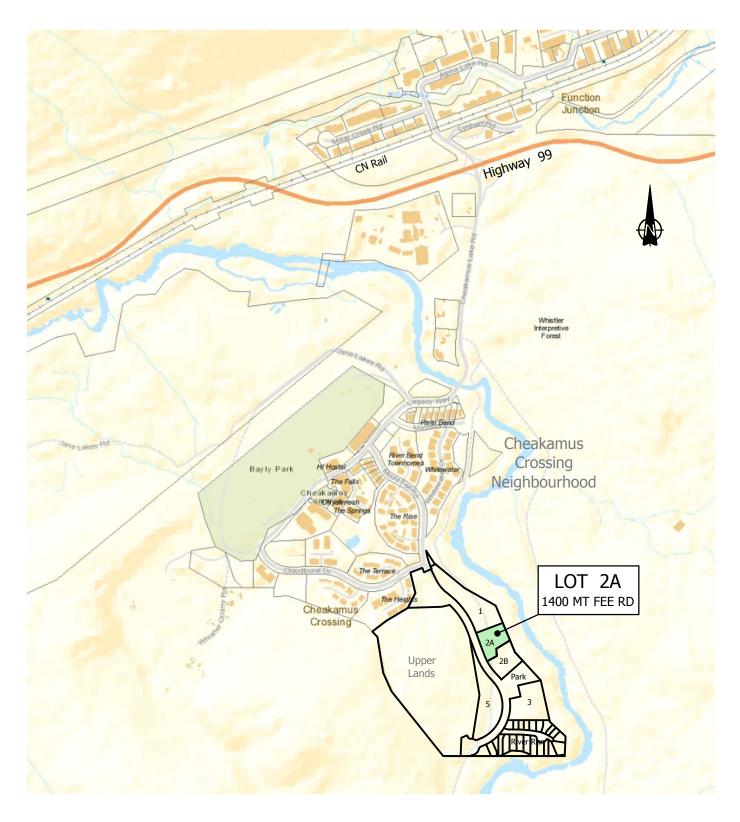


SITE LOCATION MAP SCALE 1:10,000

DRAWING LIST


DWG NO.	SHEET TITLE
(BP)ESC-1	EROSION & SEDIMENT CONTROL PLAN - LOT 2A & 2B - 1400, 1450 MOUNT FEE ROAD
(BP)S-1	SERVICING PLAN - LOT 2A - 1400 MOUNT FEE ROAD
(BP)S-2	SERVICE CONNECTION PROFILES & GENERAL NOTES - LOT 2A - 1400 MOUNT FEE ROAI
(BP)STM-1	STORM SEWER - LOT 2A & 2B - 1400, 1450 MOUNT FEE ROAD
(BP)DWY-1	ROADWORKS - LOT 2A & 2B - 1400, 1450 MOUNT FEE ROAD
(BP)TYP-1	TYPICAL CROSS-SECTIONS - LOT 2A & 2B - 1400, 1450 MOUNT FEE ROAD
(BP)GR-1	GRADING PLAN - LOT 2A & 2B - 1400, 1450 MOUNT FEE ROAD
(BP)SS-1	SITE-SECTIONS - LOT 2A - 1400 MOUNT FEE ROAD
(BP)DET-1	STANDARD DETAILS - LOT 2A & 2B - 1400, 1450 MOUNT FEE ROAD

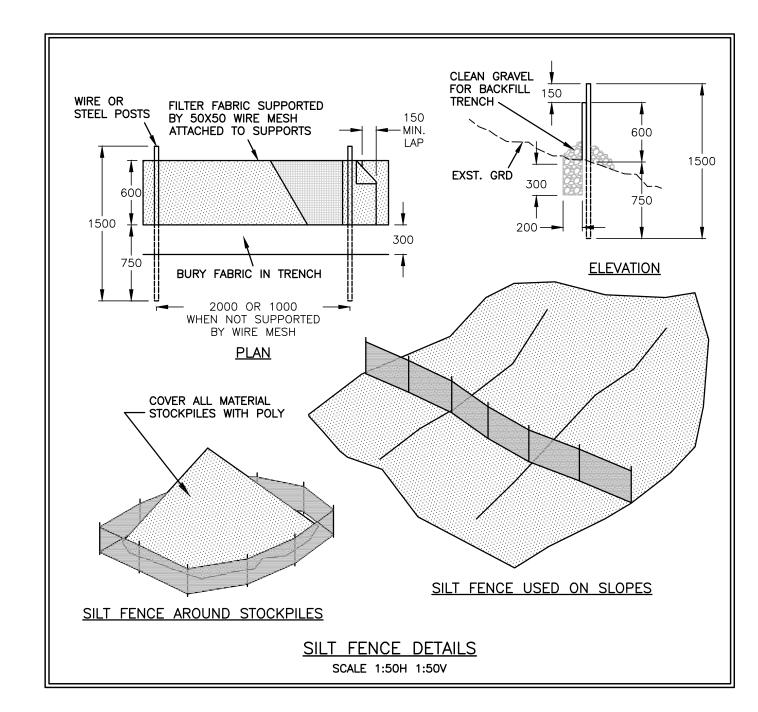


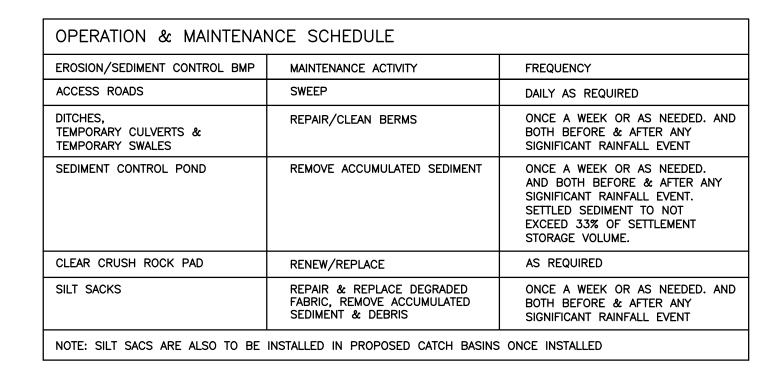


ALL FIELD CHANGES/MODIFICATIONS TO THE EROSION AND SEDIMENT CONTROL FEATURES MUST BE APPROVED BY THE ENGINEER PRIOR TO CONSTRUCTION

CONTRACTOR TO NOTIFY THE ENGINEER A MINIMUM OF 48 HOURS PRIOR TO INSTALLATION OF THE EROSION AND SEDIMENT CONTROL FEATURES SHOWN ON THIS DRAWING. CONSTRUCTION/INSTALLATION OF ALL EROSION AND SEDIMENT CONTROL FEATURES MUST PASS INSPECTION BY WEBSTER ENGINEERING LTD.

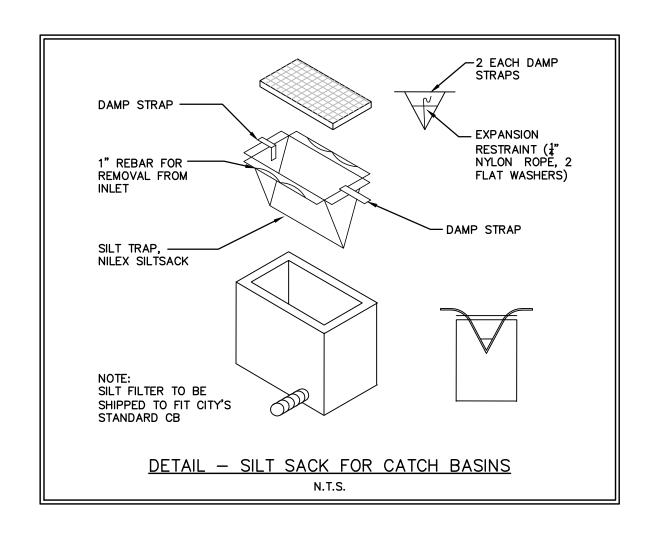

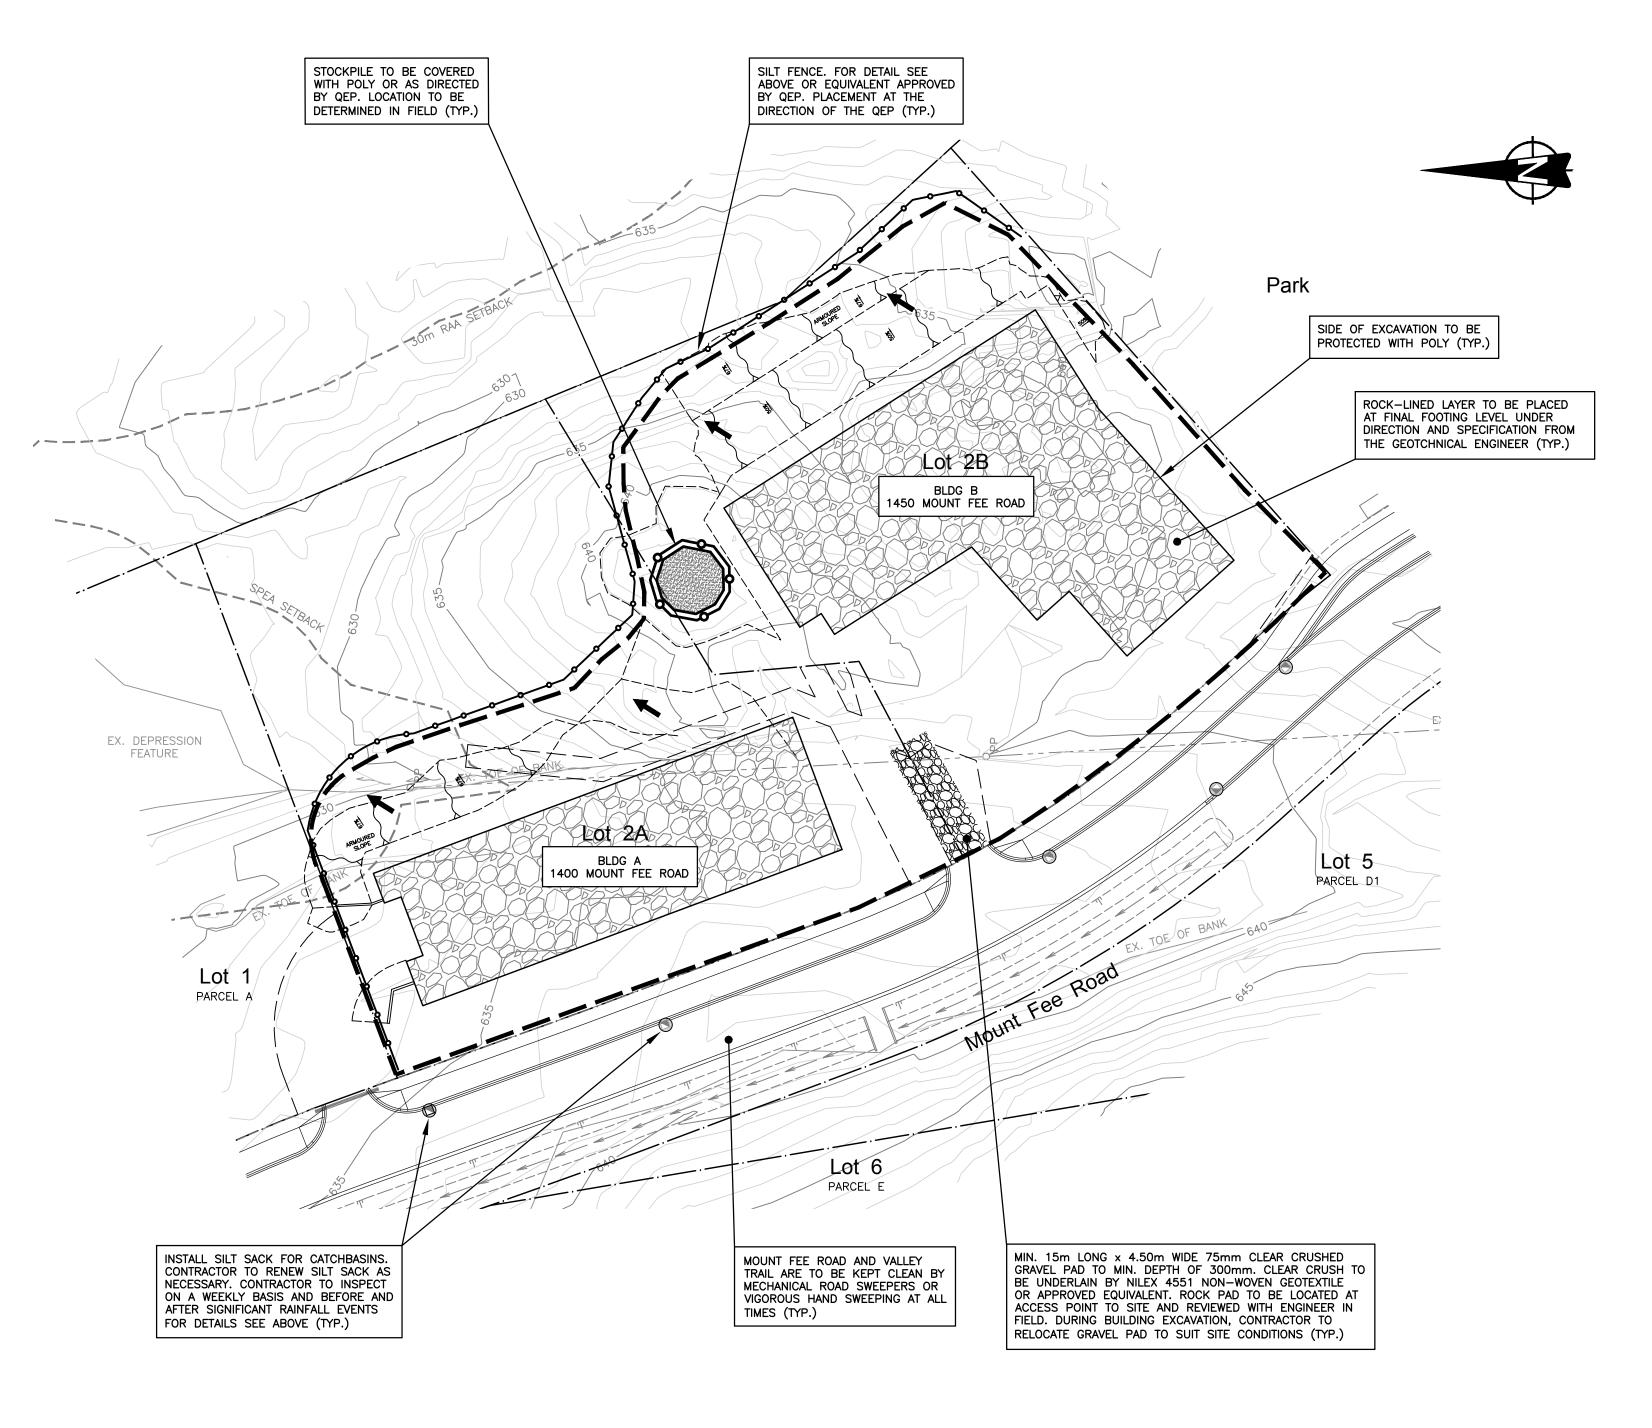

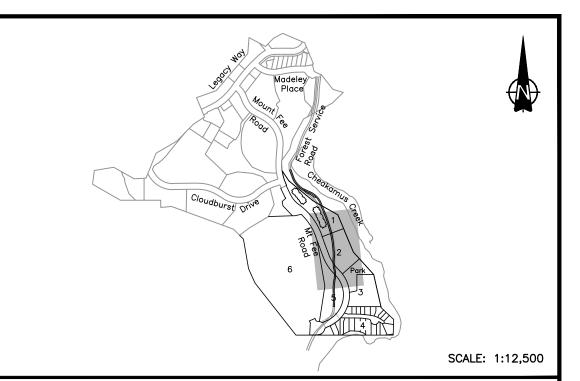

DESCRIPTION	SYMBOLS
GENERAL FALL OF ROUGH GRADE DRAINAGE	←
EXISTING DITCH	
PROPOSED TEMPORARY DITCH C/W CHECK DAMS © 15m INTERVALS	~ ~
SEDIMENT CONTROL POND	٥١
SILT FENCE	~~~~
EXISTING CULVERT	>
TEMPORARY CULVERT	>
TEMPORARY STORM PIPE	
CLEARING BOUNDARY	
PUMP SUMP	P
GRAVITY SUMP	<u> </u>
SILT SACK	
SPEA SETBACK BY CASCADE ENVIRONMENTAL RG	
FILL SLOPE	
CUT SLOPE	
ROCKSTACK WALL	

EROSION AND SEDIMENT CONTROL NOTES

- 1. THE CONTRACTOR SHALL BE RESPONSIBLE FOR INSTALLING AND MAINTAINING A SILTATION AND EROSION CONTROL SYSTEM AS SHOWN ON THESE DRAWINGS AS WELL AS ANY ADDITIONAL TEMPORARY WORKS NECESSARY TO PREVENT SILT DISCHARGES TO THE STORM DRAINAGE SYSTEM.
- 2. ALL SILTATION CONTROL DEVICES SHALL PROVIDE ACCESS FOR CLEANING AND MAINTENANCE.
- 3. ALL SILTATION CONTROL STRUCTURES MUST BE MAINTAINED DURING THE COURSE OF CONSTRUCTION THROUGH TO THE END OF THE MAINTENANCE PERIOD.
- 4. THE CONTRACTOR SHALL TAKE ALL STEPS NECESSARY TO ENSURE THAT NO SILT IS DISCHARGED TO THE STORM DRAINAGE SYSTEM, ROADWAYS OR ADJACENT PROPERTIES DURING THE COURSE OF CONSTRUCTION.
- 5. THE CONTRACTOR SHALL INSPECT THE SILTATION AND EROSION CONTROL WORKS DURING RAINFALL EVENTS AND UNDERTAKE ANY REMEDIAL WORK REQUIRED FOR FUNCTIONAL
- 6. AS CONSTRUCTION PROGRESSES AND INTERCEPTED FLOWS ARE REDUCED, THE SIZE OF THE SEDIMENT TRAP MAY BE REDUCED ACCORDINGLY AT THE DISCRETION OF THE ENGINEER AND THE RESORT MUNICIPALITY OF WHISTLER (RMOW).
- 7. CONSTRUCTION AND MAINTENANCE OF THE SEDIMENT AND EROSION CONTROL MEASURES MUST BE INSTALLED AND MUST MEET OR EXCEED THE STANDARDS OUTLINED IN THE LATEST EDITION OF THE DEPARTMENT OF FISHERIES AND OCEANS 'LAND DEVELOPMENT GUIDELINES FOR THE PROTECTION OF AQUATIC HABITAT' AND THE RMOW'S SUBDIVISION AND DEVELOPMENT SERVICING AND STORMWATER MANAGEMENT BYLAWS NO. 1175, 2012.
- 8. THE SUPPLY AND INSTALLATION OF SILT FENCES SHALL BE AS PER SECTION 3 AND FIGURE 3.3 OF THE DEPARTMENT OF FISHERIES AND OCEANS 'LAND DEVELOPMENT GUIDELINES FOR THE PROTECTION OF AQUATIC HABITAT'.
- 9. THE CONTRACTOR SHALL CONSTRUCT ALL NECESSARY SILTATION AND EROSION CONTROL WORKS BEFORE COMMENCING ANY OTHER ON-SITE CONSTRUCTION OTHER THAN
- 10. PROTECT EXPOSED SLOPES WITH FASTENED POLYETHYLENE SHEETING OR OTHER APPROVED COVER. MINIMIZE SURFACE DISTURBANCE AND THE AMOUNT OF TIME

SURFACES ARE EXPOSED.

- 11. DESIGNATE AN AREA FOR SOIL STOCKPILING AND KEEP ALL MATERIALS (E.G. SAND, GRAVEL, SPOIL MATERIAL, CONCRETE MIX) OFF PAVED SURFACES AND AS FAR AS POSSIBLE FROM THE TOP OF BANK (I.E. NATURAL BOUNDARY) OF ANY WATER COURSE OR THE STORM WATER SYSTEM. PROTECT STOCKPILES WITH POLYETHYLENE SHEETING AND, IF REQUIRED, SILT FENCING.
- 12. ANY FILL USED ON SITE MUST BE INERT MATERIAL, FREE OF CONTAMINANTS OR ANY OTHER SUBSTANCES DELETERIOUS TO AQUATIC LIFE.
- 13. ALL SITE RUNOFF MUST CONTAIN TOTAL SUSPENDED SOLIDS (TSS) OF LESS THAN 25 mg/L ABOVE BACKGROUND DURING DRY MONTHS AND LESS THAN 75 MG/L ABOVE BACKGROUND DURING WET MONTHS, AND MEASURE TSS AT THE MONITORING POINT AS
- 14. ENVIRONMENTAL MONITORING IS TO BE CONDUCTED BY THE ENGINEER OF RECORD OR THE APPROVED ENVIRONMENTAL CONSULTANT, INCLUDING INSPECTING AND REPORTING OF THE CONSTRUCTION WORK AND THE WATER QUALITY. SEQUENCING TO BE DETERMINED WITH THE RMOW. MONITORING IS TO OCCUR UNTIL 90% OF CONSTRUCTION IS COMPLETE. MONITORING REPORTS ARE TO BE SUBMITTED TO THE RMOW WITHIN ONE WEEK OF EACH SITE INSPECTION.
- 15. ADDITIONAL SEDIMENT CONTROL MEASURES MAY BE REQUIRED AT THE REQUEST OF THE RMOW UNDER THE APPROVAL OF THE ENGINEER OF RECORD OR APPROVED ENVIRONMENTAL CONSULTANT.
- 16. THE CONTRACTOR SHALL AT MINIMUM INSTALL, MONITOR AND REGULARLY MAINTAIN:
 -SEDIMENT SACKS AT ALL CATCH BASINS AFFECTED BY CONSTRUCTION -CONTROLLED VEHICLE ACCESS -SITE PERIMETER FENCING -SLOPE AND STOCKPILE PROTECTION -COLLECTION SWALES OR PUMP HOSE

								client	
								WHISTLER DEVELOPMENT CORPORATION	
								project - CHEAKAMUS CROSSING NEIGHBOURHOOD EXPANSION	
1	NOV.28.22	BUILDING PERMIT SUBMISSION #1	MJF					WHISTLER, BRITISH COLUMBIA	
no	date	revision	chk'd	no	data	revision	chk'd	·	



EGBC PERMIT No. 1001444

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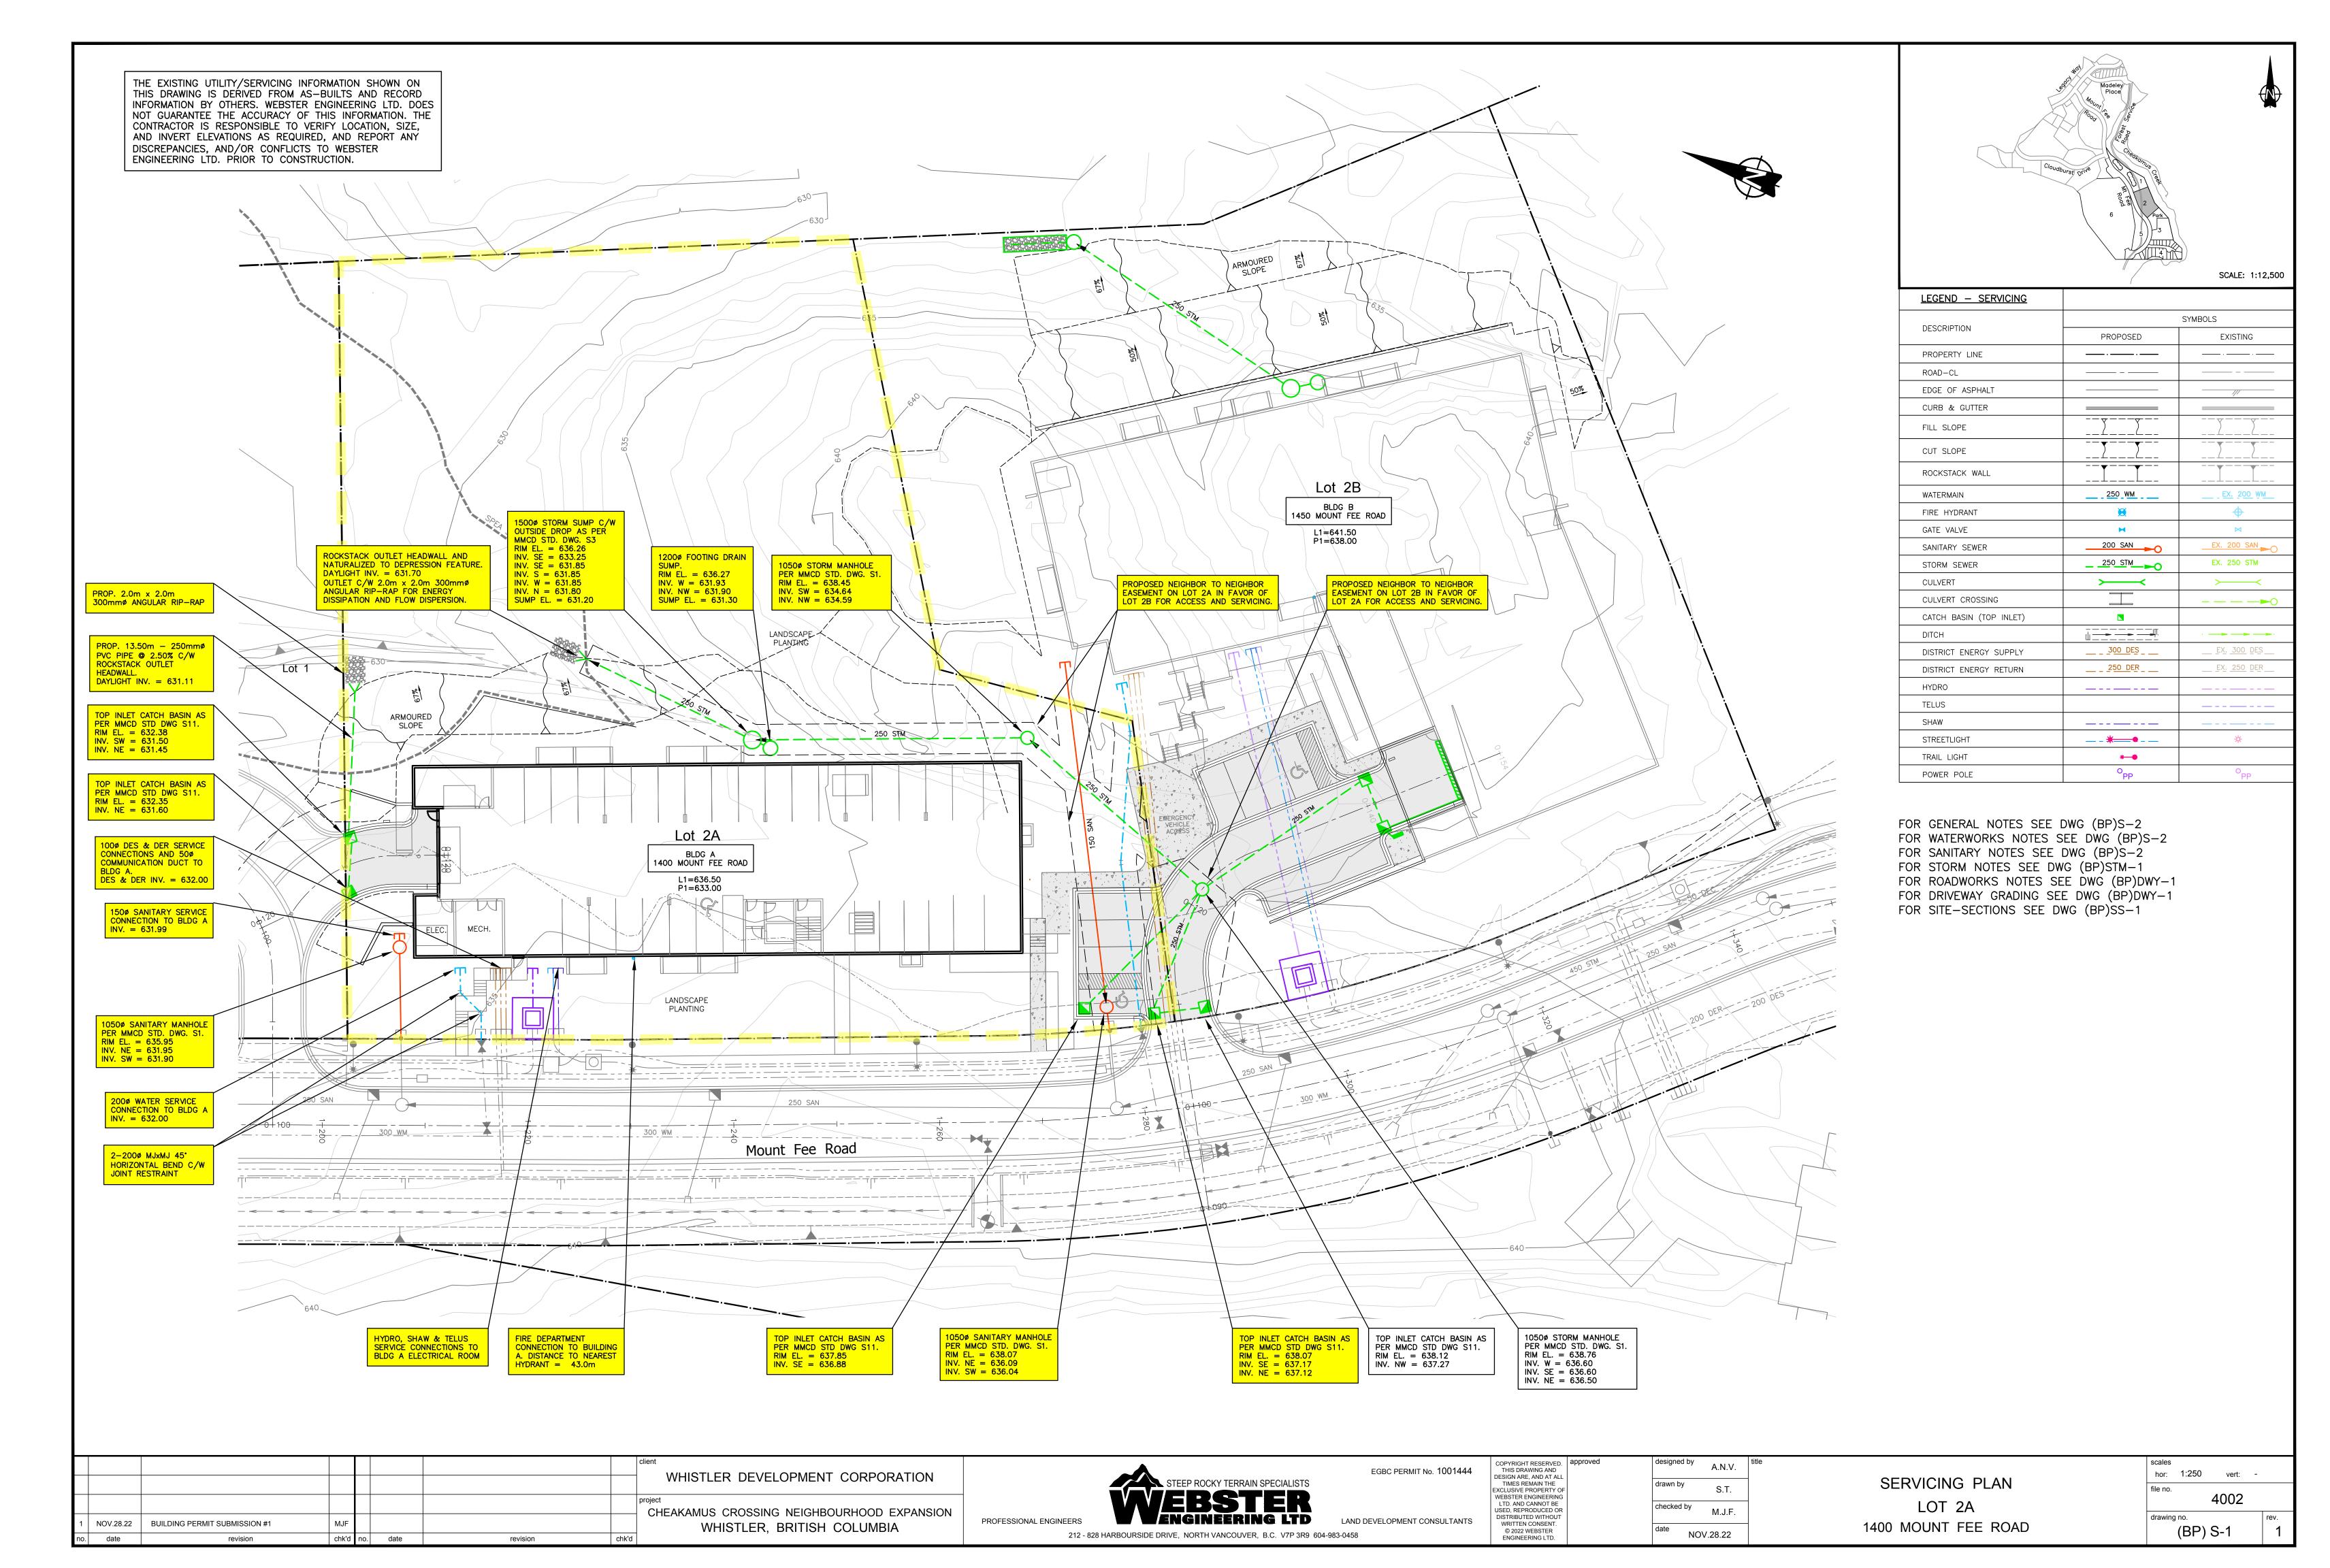
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EROSION & SEDIMENT CONTROL PLAN LOT 2A & 2B


1400, 1450 MOUNT FEE ROAD

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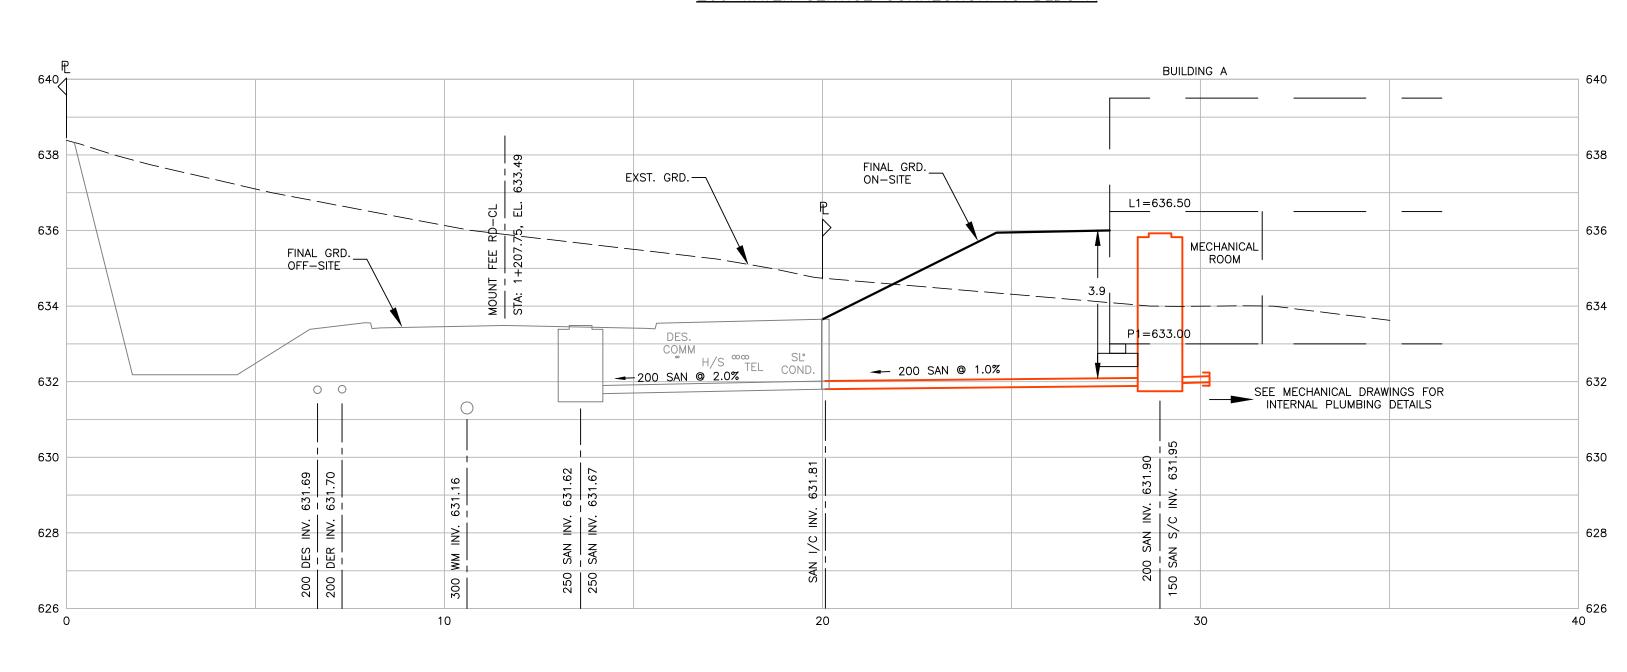
(BP) ESC-1



F:\4000\4002 Cheakamus Creek - Phase 2, Whistler\DESIGN\LOT 2 & 3 DP\SERVICING PLAN - LOT 2A.dwg, 11/29/2022 4:35:0

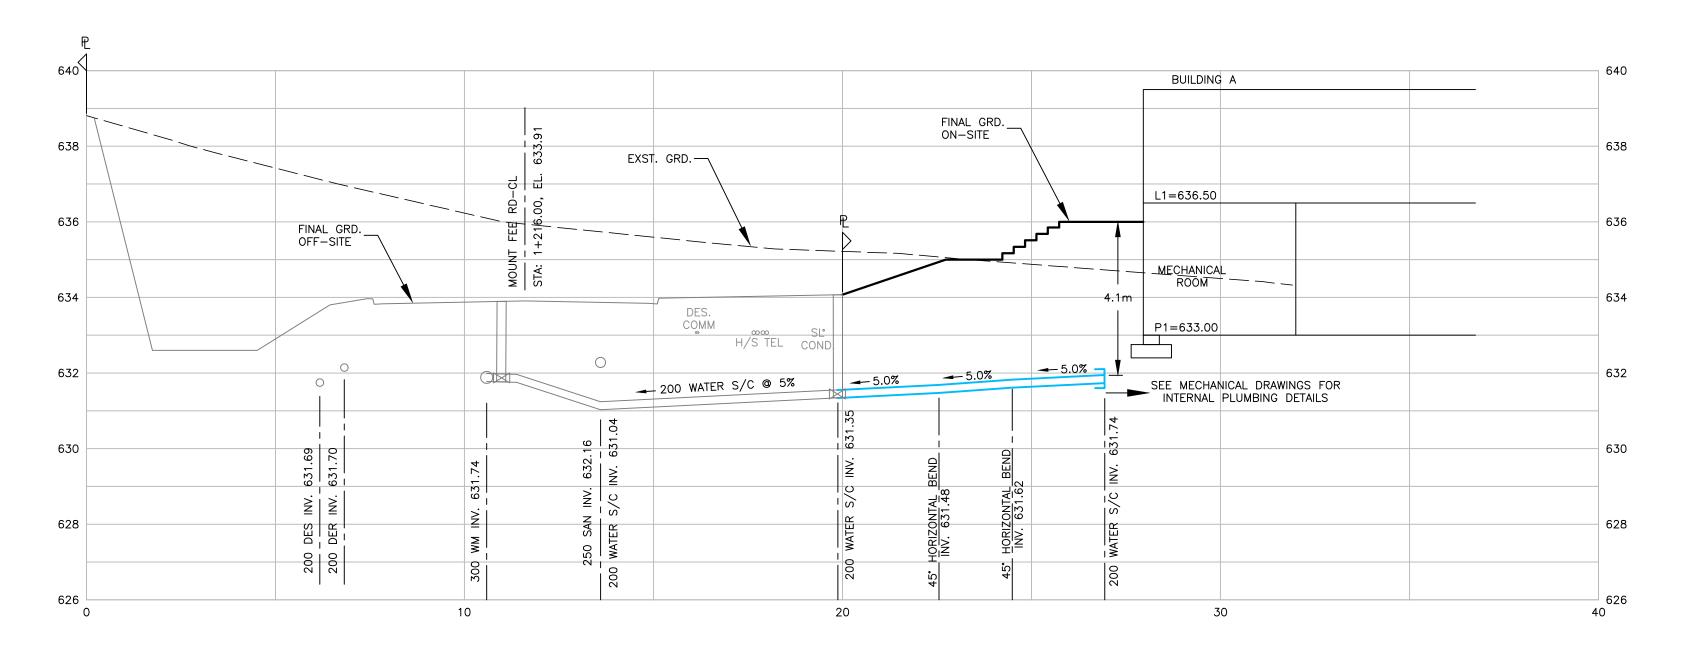

200 WATER SERVICE CONNECTION TO BLDG A



150 SANITARY SERVICE CONNECTION TO BLDG A

WHISTLER DEVELOPMENT CORPORATION CHEAKAMUS CROSSING NEIGHBOURHOOD EXPANSION NOV.28.22 **BUILDING PERMIT SUBMISSION #1** WHISTLER, BRITISH COLUMBIA chk'd revision



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SERVICE CONNECTION PROFILES & GENERAL NOTES LOT 2A

1400 MOUNT FEE ROAD

hor: 1:100 vert: 1:100 4002

(BP) S-2

drawing no.

GENERAL NOTES

- 1. ALL CONSTRUCTION MUST CONFORM TO THE RESORT MUNICIPALITY OF WHISTLER (RMOW) GENERAL SPECIFICATIONS AND MUST PASS WEBSTER ENGINEERING AND/OR RMOW INSPECTION ON COMPLETION OF EACH STAGE OF CONSTRUCTION. THE CONTRACTOR WILL GIVE RMOW 48 HOURS NOTICE PRIOR TO THIS REQUIREMENT FOR INSPECTION.
- 2. THE CONTRACTOR SHALL ENSURE THAT ALL APPROVALS REQUIRED FOR THE PROPOSED WORK HAVE BEEN OBTAINED PRIOR TO COMMENCEMENT OF ANY CONSTRUCTION.
- 3. LOCATIONS OF EXISTING UNDERGROUND SERVICES HAVE BEEN DETERMINED FROM RMOW AND UTILITIES AS-CONSTRUCTED DRAWINGS. CONTRACTOR TO VERIFY THE LOCATION OF ALL EXISTING SERVICES AND TO NOTIFY ENGINEER OF ANY DISCREPANCIES, CONFLICTS OR OMISSIONS PRIOR TO BEGINNING CONSTRUCTION.
- 4. ALL CUTS IN EXISTING ASPHALT REQUIRED FOR TRENCHING SHALL BE SAWCUT & REPLACED WITH MINIMUM 100mm ASPHALT, 150mm GRANULAR BASE & 300mm GRANULAR SUBBASE AFTER BACKFILL AND COMPACTION. ALL PAVEMENTS BOULEVARDS, ETC. ARE TO BE RESTORED TO ORIGINAL CONDITION WHEN NO IMPROVEMENT IS PROPOSED UNDER THIS CONTRACT.
- 5. THE CONTRACTOR SHALL USE EXTREME CARE WHEN WORKING NEAR EXISTING SERVICES AND ANY SERVICES DISTURBED ARE TO BE REPLACED TO THE SATISFACTION OF RMOW, THE ENGINEER AND /OR APPROPRIATE UTILITY CORPORATION.
- 6. THE CONTRACTOR'S SURVEYOR WILL RECORD ALL INFORMATION REQUIRED FOR THE ENGINEER TO PROVIDE A COMPLETE SET OF AS-CONSTRUCTED DRAWINGS.
- 7. WHEN NO IMPROVEMENTS ARE PROPOSED UNDER THIS CONTRACT, THE EXISTING SECTION(S) OF ROADWAY SHALL BE KEPT CLEAN AND CLEAR FOR THE DURATION OF CONSTRUCTION AND LEFT IN SAME CONDITION AS PRIOR TO CONSTRUCTION.
- 8. VEHICULAR ACCESS TO EXISTING DWELLINGS TO BE MAINTAINED BY THE CONTRACTOR FOR THE DURATION OF THE CONTRACT.
- 9. RESIDENTS DIRECTLY AFFECTED BY CONSTRUCTION OF THIS PROJECT SHALL BE GIVEN 48 HOURS WRITTEN NOTICE OF THE PROPOSED START OF CONSTRUCTION. IF CONSTRUCTION ENTERS ONTO PRIVATE PROPERTY, THE CONTRACTOR OR DEVELOPER'S AGENT WILL REQUIRE WRITTEN AUTHORIZATION FROM THE PRIVATE PROPERTY OWNER.
- 10. FOR BC HYDRO, TELUS & FORTIS INSTALLATION, SEE APPROPRIATE UTILITY COMPANY DRAWINGS & SPECIFICATIONS. LAYOUT SHOWN FOR REFERENCE ONLY.
- 11. ALL UTILITY STRUCTURES LOCATED WITHIN MULTI-USE PATH TO BE H20 LOAD RATED (INCLUDES HYDRO, TELUS, AND SHAW STRUCTURES).
- 12. THE CONTRACTOR SHALL TAKE ALL STEPS NECESSARY TO ENSURE THAT NO SILT IS DISCHARGED TO THE STORM DRAINAGE SYSTEM, ROADWAYS OR ADJACENT PROPERTIES DURING THE COURSE OF CONSTRUCTION IN ACCORDANCE WITH DFO/MOELP'S "LAND DEVELOPMENT GUIDELINES FOR THE PROTECTION OF AQUATIC HABITAT".
- 13. ALL CONSTRUCTION TRAFFIC MANAGEMENT SIGNS TO BE RELOCATED AS REQUIRED.


WATERWORKS NOTES


- 1. WATERMAIN AND SERVICES 100mm AND LARGER TO BE POLYVINYL CHLORIDE (P.V.C.) DR 18 TO AWWA C900, CSA B137.3 AND ULC APPROVED, UNLESS NOTED OTHERWISE. TYTON JOINTS
- 2. CURBS STOPS SHALL BE PROVIDED FOR EACH SERVICE AND SERVICE CONNECTIONS TO BE MARKED WITH 40mm X 90mm POST PAINTED BLUE @ TERMINATION AS PER RMOW DRAWING
- 3. IRRIGATION CONNECTIONS TO BE POLYETHYLENE TO AWWA C901. PRESSURE CLASS 160 TUBING CERTIFIED TO CSA B137.1.
- 4. ALL FITTINGS SHALL BE DUCTILE IRON TO AWWA C110, CEMENT MORTAR LINED TO AWWA C104, TYTON JOINTS TO AWWA C1111 WITH CLOSED LUGS EXCEPT FOR HYDRANT ASSEMBLIES.
- 5. INSTALLATION, TESTING AND CHLORINATING TO BE PERFORMED IN ACCORDANCE WITH MMCD, AWWA C900, AWWA M23 AND AWWA C651. TESTING, CHLORINATING AND FLUSHING OF WATERMAINS TO BE COORDINATED BY CONTRACTOR UNDER THE SUPERVISION OF THE ENGINEER. WORKING PRESSURE = 1050 kPA (150 psi).
- 6. DURING CONSTRUCTION AND AT ANY TIME PRIOR TO ACCEPTANCE AND PRESSURISING OF WATERMAINS BY THE WATER UTILITY, THE CONTRACTOR SHALL INSTALL A 300mm X 300mm SQUARE, 19mm SHEET OF PLYWOOD OVER THE PUMP NOZZLE OF EACH HYDRANT TO INDICATE THAT HYDRANT IS NOT IN USE.
- 7. HYDRANTS TO BE SURROUNDED BY 1.0m RADIUS ASPHALT APRON.
- 8. AIR VALVES TO BE 25mm TO RMOW STD. DWG W6-A. FIRE HYDRANTS TO R.M.O.W. STD. DWG W4. GATE VALVES TO BE RESILIENT SEATED TO MMCD W3 (TC/CLOW RESILIENT WEDGE).
- 9. WHERE THERE IS LESS THAN 0.5m VERTICAL SEPARATION OF WATERMAIN FROM STORM SEWER/CULVERT CROSSING OR 3m HORIZONTALLY FROM STORM/SANITARY MAIN, FOLLOW MINISTRY OF HEALTH GUIDELINES FOR WRAPPING JOINTS. WHERE THERE IS LESS THAN 0.3m VERTICAL SEPARATION, ENCASE WATERMAIN IN CONCRETE AS PER MMCD G6.
- 10. VALVES AND FIRE HYDRANTS ON THE EXISTING WATER SYSTEM SHALL NOT BE OPERATED WITHOUT THE PERMISSION OF THE WATER UTILITY.
- 11. CONTRACTOR TO USE DENSO TAPE OR ZINC-RICH PAINT ON ALL UNCOATED STEEL INCLUDING BUT NOT LIMITED TO VALVES, BENDS, TEES, NUTS, BOLTS AND TIE RODS. ALL METALLIC PARTS COMPLETE WITH CORROSIVE PROTECTIVE COATINGS.
- 12. JOINT RESTRAINTS TO MMCD SPECIFICATION SECTION 02666 TO BE INSTALLED WHERE GRADE EXCEEDS 20% OR AS SPECIFIED.
- 13. WHERE WATERMAIN PIPE EXCEEDS 10% PIPE TO BE ANCHORED AS PER MMCD STD. DWG G8. 14. CONTRACTOR TO MAKE TIE-IN(S) TO EXISTING WATERMAIN(S) UNDER SUPERVISION OF RMOW


INSPECTOR. CONTRACTOR TO ADVISE RMOW 48 HOURS PRIOR TO TIE-IN.

- SANITARY NOTES
- 1. ALL WORKS SHALL BE CONSTRUCTED IN ACCORDANCE WITH THE LATEST STANDARDS & SPECIFICATIONS OF THE RESORT MUNICIPALITY OF WHISTLER (RMOW), BC BUILDING CODE AND PLUMBING CODE, MASTER MUNICIPAL CONSTRUCTION DOCUMENTS (MMCD), WORKSAFE AND WITH THE NOTES & DETAILS OF THIS DRAWING.
- GRAVITY SANITARY SEWERS ARE PVC SDR 28 FOR SERVICE CONNECTIONS AND SDR 35 FOR MAIN LINES WHEN TESTED IN ACCORDANCE WITH ASTM D3034 & CSA B182.1. PIPE STIFFNESS (f/y) IS 314 kPa AT 5% DEFLECTION WHEN TESTED IN ACCORDANCE WITH ASTM
- 3. ALL GRAVITY SANITARY SEWER SERVICE CONNECTIONS TO BE 200mm DIAMETER CONNECTED TO THE MAIN WITH MANUFACTURED WYE OR TO THE MANHOLE AS PER MMCD STD. DWG S7. 200mm DIAMETER INSPECTION CHAMBER TO BE INSTALLED AT PROPERTY LINE AS PER MMCD
- 4. SANITARY SERVICE CONNECTIONS TO BE MARKED WITH A 50mm x 100mm POST PAINTED GREEN AND RED RESPECTIVELY. THE BELL END AND CAP AT THE TERMINATION IS ALSO TO BE PAINTED GREEN AND RED TO SUIT.
- MINIMUM GRADE ON SERVICE CONNECTIONS TO BE 2% UNLESS NOTED OTHERWISE, SERVICE CONNECTIONS AS PER R.M.O.W. STD. DWG S7-A.
- 6. ALL MANHOLES ARE 1050mm I.D. UNLESS NOTED OTHERWISE. MANHOLES AS PER R.M.O.W. STD. DWG S1.
- 7. ALL SEWERS ARE TO BE T.V. CAMERA INSPECTED AND CERTIFIED BY DESIGN ENGINEER. T.V. CAMERA INSPECTIONS ARE TO BE ARRANGED AND PAID FOR BY THE CONTRACTOR.
- 8. TESTING OF SANITARY SEWERS AND SERVICE CONNECTIONS TO BE ARRANGED AND PAID FOR BY CONTRACTOR AND PERFORMED IN THE PRESENCE OF RMOW INSPECTOR AND ENGINEER. 72 HOURS PRIOR NOTICE REQUIRED.
- 9. TESTING OF SANITARY SEWERS PERFORMED IN THE PRESENCE OF DESIGN ENGINEER INSPECTORS. MINIMUM 48 HOURS NOTICE REQUIRED.
- 10. ALL SEWER SERVICE CONNECTIONS ENTERING MANHOLES TO HAVE AN INVERT ELEVATION AT CROWN ELEVATION OF DOWNSTREAM SEWER OUTLET.
- 11. WHERE SANITARY PIPE GRADE EXCEEDS 15%, PIPE IS TO BE ANCHORED AS PER MMCD STD.
- 12. SANITARY SEWERS TO BE CONCRETE ENCASED AS PER R.M.O.W. STD. DWG G9 C/W 50mm RIGID FOAM INSULATION OVER PIPE WHERE MIN. COVER CANNOT BE ACHIEVED.
- 13. WHERE SANITARY SEWER CROSSES A WATERMAIN AND CLEARANCE IS LESS THAN 0.5m, THE WATERMAIN IS TO BE ENCASED AS PER R.M.O.W. STD. DWG G9.
- 14. PIPE BEDDING TO CONFORM WITH R.M.O.W. STANDARDS. SEE R.M.O.W. STD. DWGS G4 & G9.
- 15. MIN. COVER = 1.5m FOR ALL SANITARY PIPE.
- 16. LOCATION/INVERTS OF SERVICE CONNECTIONS CONFIRMED BY ENGINEER ONCE ROUGH GRADING IS COMPLETE.
- 17. TRENCH BEDDING AND BACKFILL TO BE AS PER MMCD STD. DWG. G4.

NOV.28.22

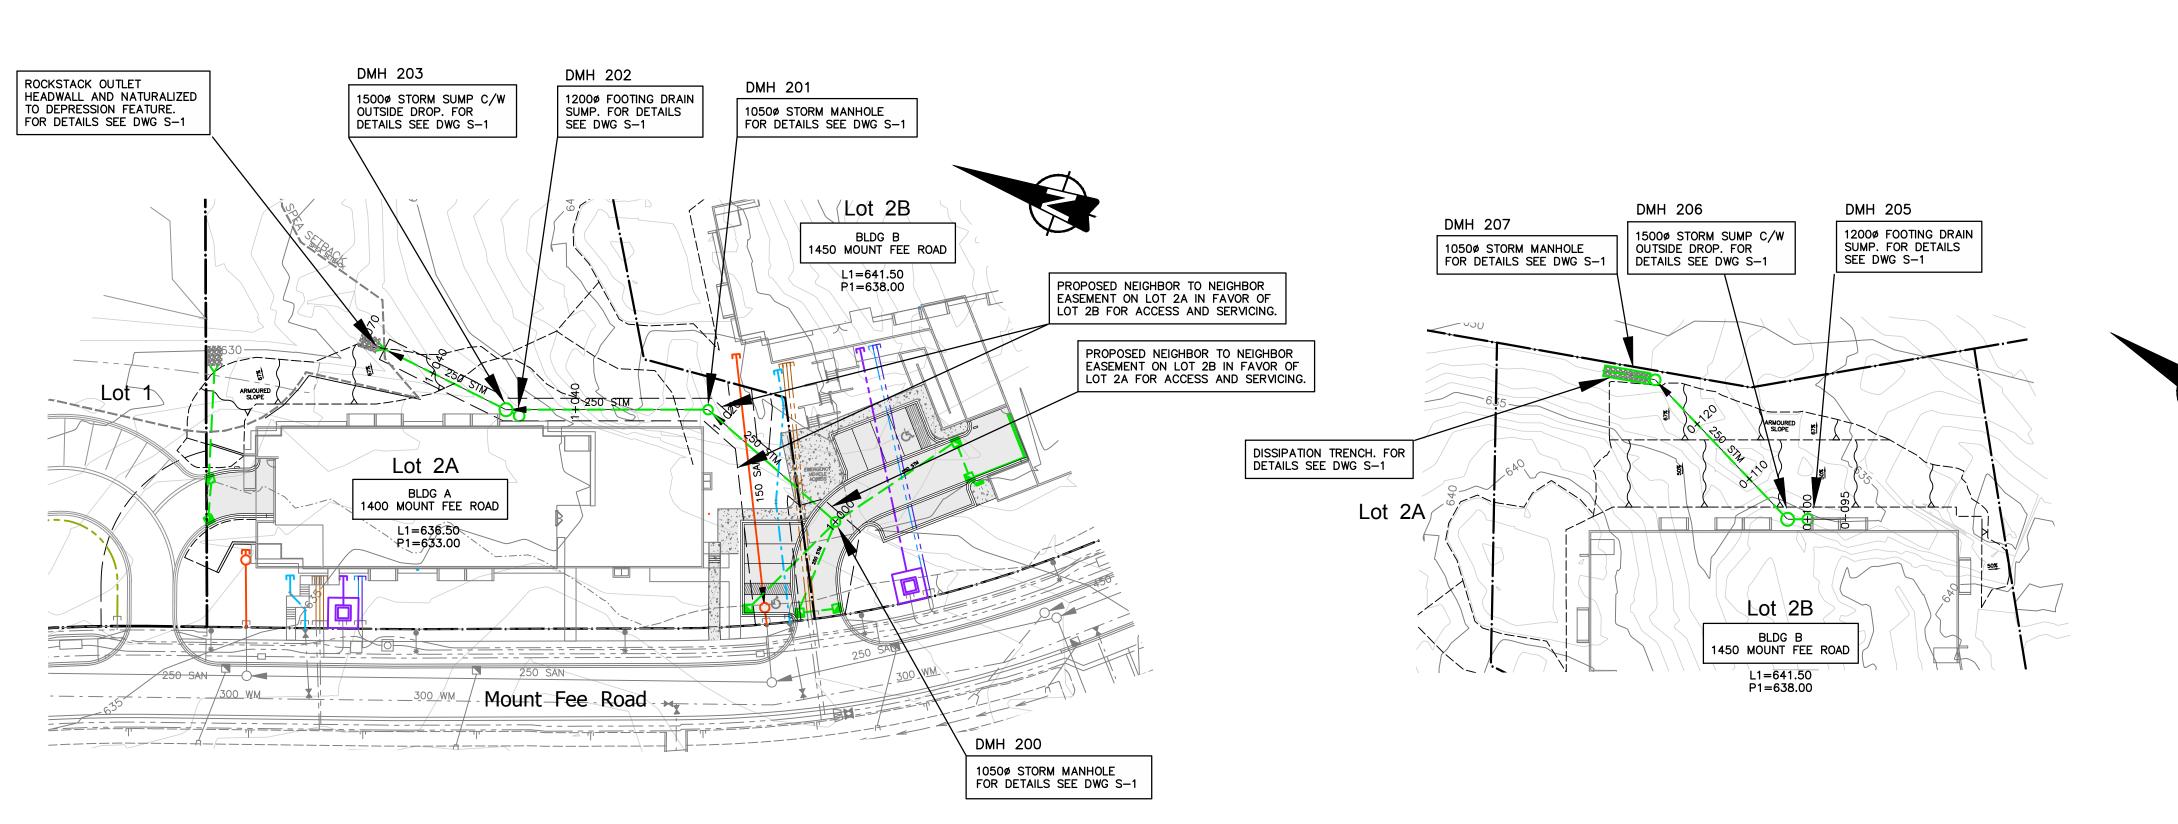

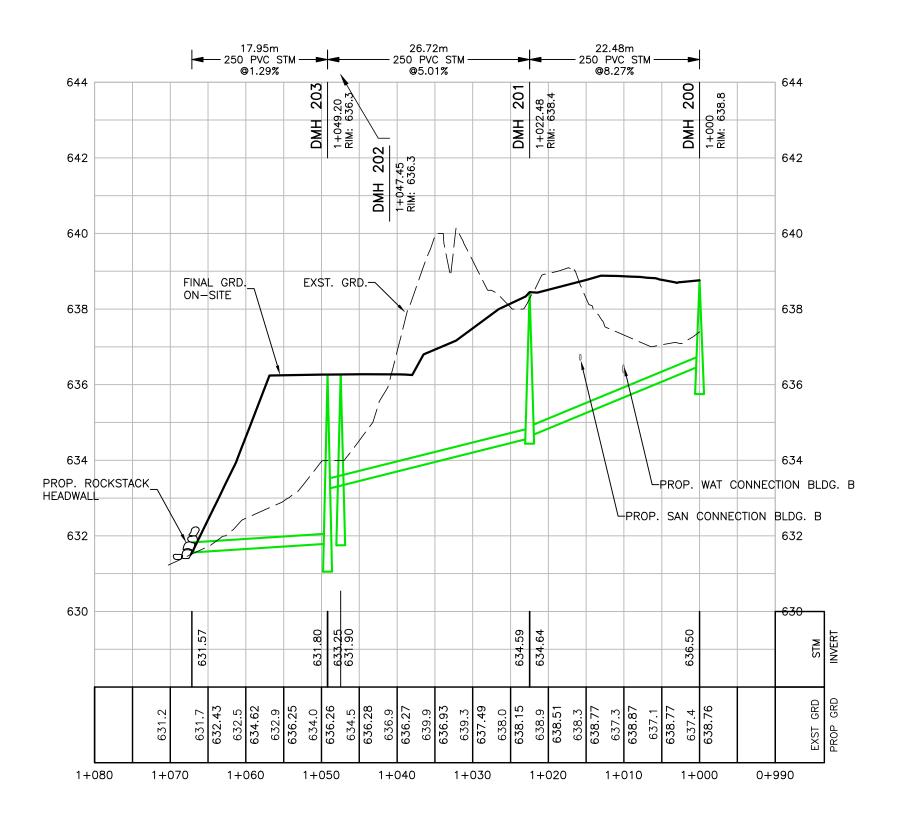

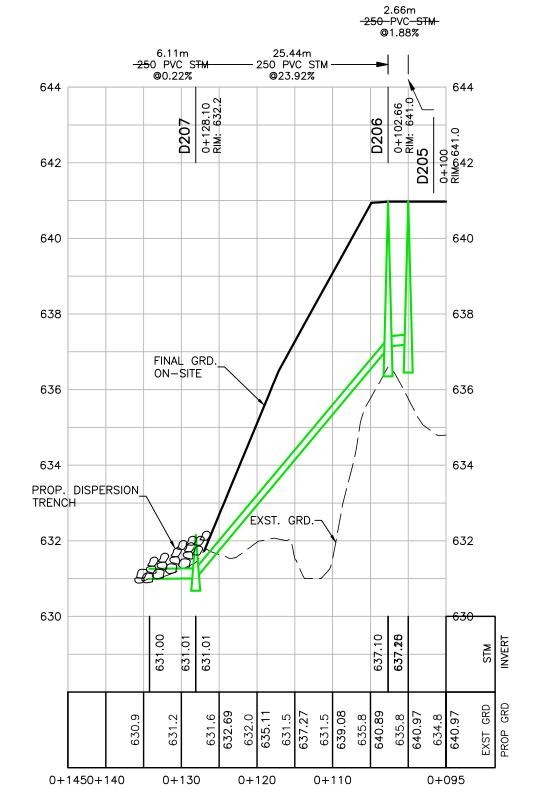

STORM SEWER NOTES

- 1. STORM SEWER MAINS TO BE CONCRETE AND SHALL MEET THE ASTM C-76 CLASS III SPECIFICATIONS FOR REINFORCED PIPE OR BE PVC SDR 35 WHEN TESTED IN ACCORDANCE WITH STM D3034 & CSA B182.1. STORM SERVICES TO BE PVC SDR 28.
- 2. STORM SEWER SERVICE CONNECTIONS TO BE 150mm DIA. CONNECTED TO THE MAIN WITH MANUFACTURED WYE OR TO THE MANHOLE. WHERE NO STORM SEWER SERVICE CONNECTION IS SHOWN LOT DRAINAGE TO BE CONNECTED TO DITCH.
- 3. ALL MANHOLES TO BE 1050mm I.D. & CONFORM TO RMOW STD DWG S1, UNLESS NOTED OTHERWISE.
- 4. CATCH BASIN LEADS TO BE 200mm DIAMETER P.V.C. S.D.R. 35.
- 5. ALL SEWERS TO BE T.V. CAMERA INSPECTED. T.V. CAMERA INSPECTION TO BE ARRANGED AND PAID FOR BY THE CONTRACTOR.
- 6. MINIMUM GRADE ON SERVICE CONNECTIONS AND CATCH BASIN LEADS TO BE 2%, UNLESS NOTED OTHERWISE.
- 7. PIPE BEDDING TO CONFORM WITH THE RMOW STANDARDS AND MANUFACTURER'S SPECIFICATIONS. SEE RMOW STD DWG G4 & G9.
- 8. CONTRACTOR TO INSTALL SEWER SERVICES UNLESS NOTED OTHERWISE.
- 9. CATCH BASINS AS PER MMCD STD DWG S11 & SIDE INLET CATCH BASIN TO MMCD STD DWG S11 AND RMOW STD. DWG S16. FOR ADDITIONAL GRATE INFORMATION SEE RMOW STD. DWG S12.
- 10. CONCRETE ENCASE ALL PIPES GOING THROUGH ROCK STACKS.
- 11. MINIMUM COVER ON CULVERTS SHALL BE 450mm.
- 12. ALL EXISTING CULVERTS TO BE CLEANED AND FLUSHED AND INSPECTED BY ENGINEER FOR CONDITION.
- 13. WHERE SEWER MAIN CROSSES WATERMAIN AND CLEARANCE IS LESS THAN 0.5m, THE UPPER PIPE SHALL BE ENCASED AS PER R.M.O.W. STD. DWG G9.

WHISTLER DEVELOPMENT CORPORATION CHEAKAMUS CROSSING NEIGHBOURHOOD EXPANSION WHISTLER, BRITISH COLUMBIA NOV.28.22 BUILDING PERMIT SUBMISSION #1 chk'd revision

VENGINEERING LTD LAND DEVELOPMENT CONSULTANTS PROFESSIONAL ENGINEERS 212 - 828 HARBOURSIDE DRIVE, NORTH VANCOUVER, B.C. V7P 3R9 604-983-0458

EGBC PERMIT No. 1001444


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NOV.28.22

STORM SEWER LOT 2A & 2B 1400, 1450 MOUNT FEE ROAD hor: 1:500 vert: 1:100 4002

(BP) STM-1



F:\4000\4002 Cheakamus Creek - Phase 2, Whistler\DESIGN\LOT 2 & 3 DP\ROADWORKS - LOT 2.dwg, 11/29/2022 4:21:23 PM,

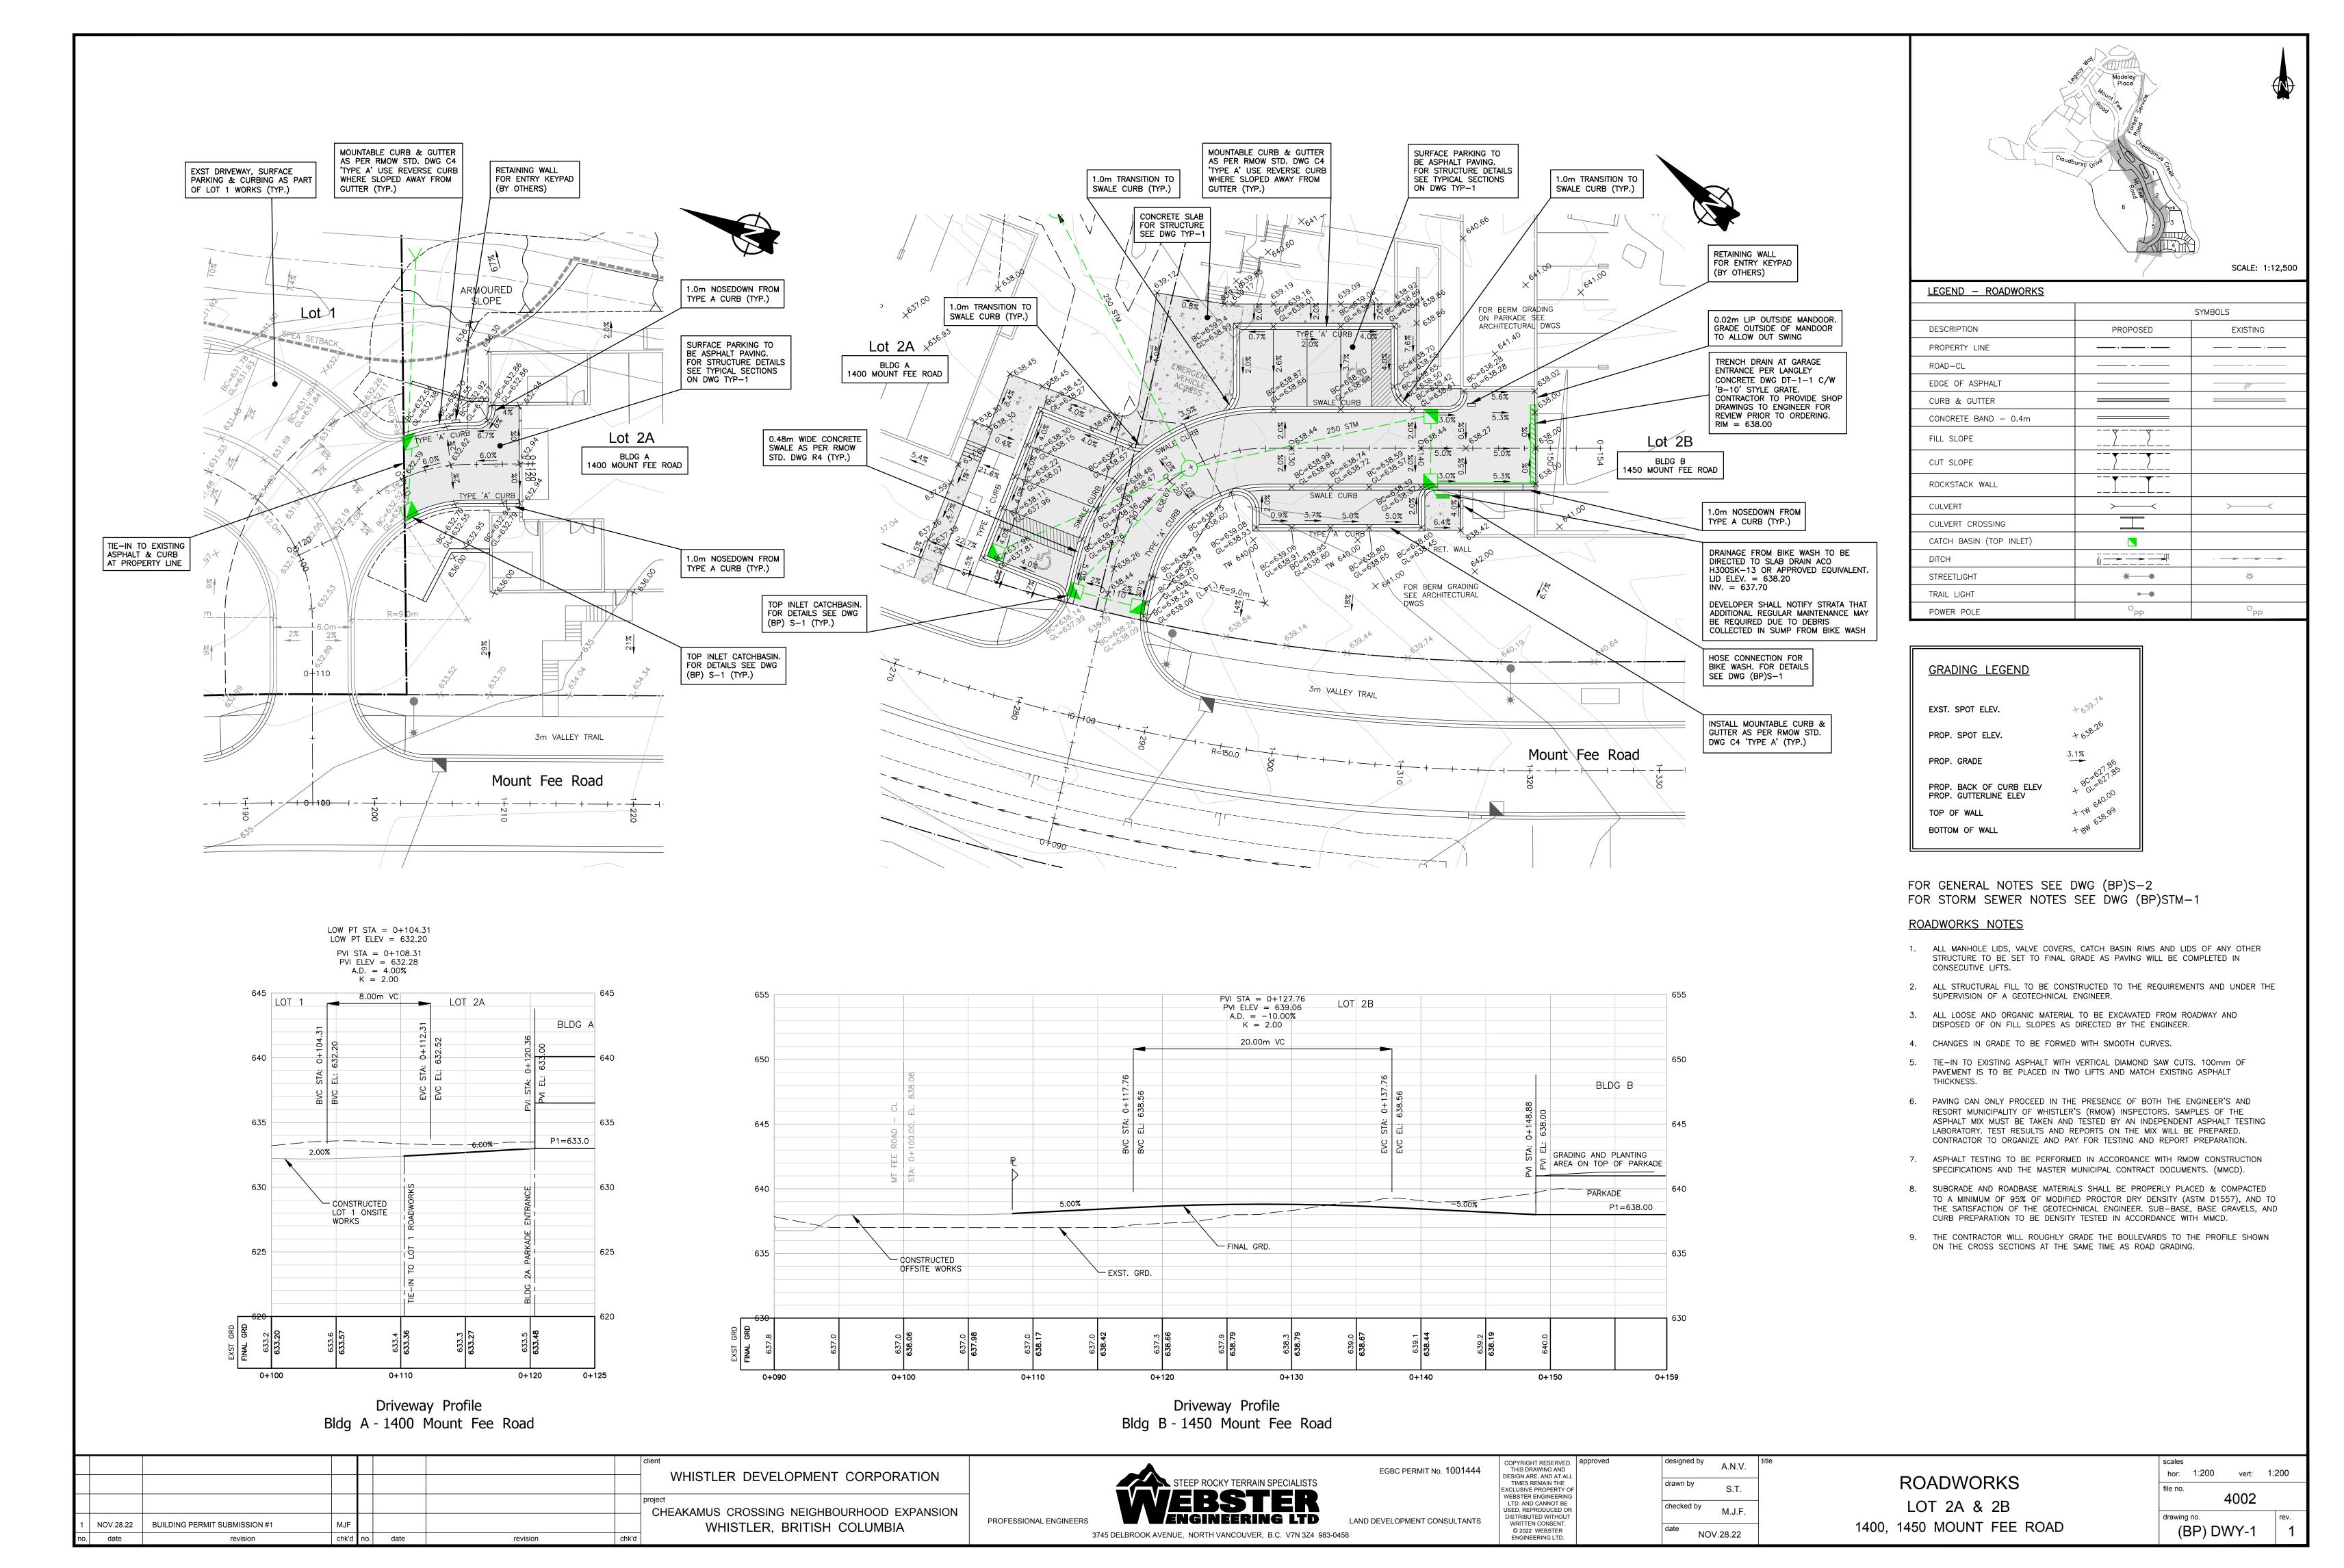WHISTLER DEVELOPMENT CORPORATION CHEAKAMUS CROSSING NEIGHBOURHOOD EXPANSION NOV.28.22 BUILDING PERMIT SUBMISSION #1 WHISTLER, BRITISH COLUMBIA chk'd revision


STEEP ROCKY TERRAIN SPECIALISTS WENGINEERING LTD PROFESSIONAL ENGINEERS LAND DEVELOPMENT CONSULTANTS 3745 DELBROOK AVENUE, NORTH VANCOUVER, B.C. V7N 3Z4 983-0458


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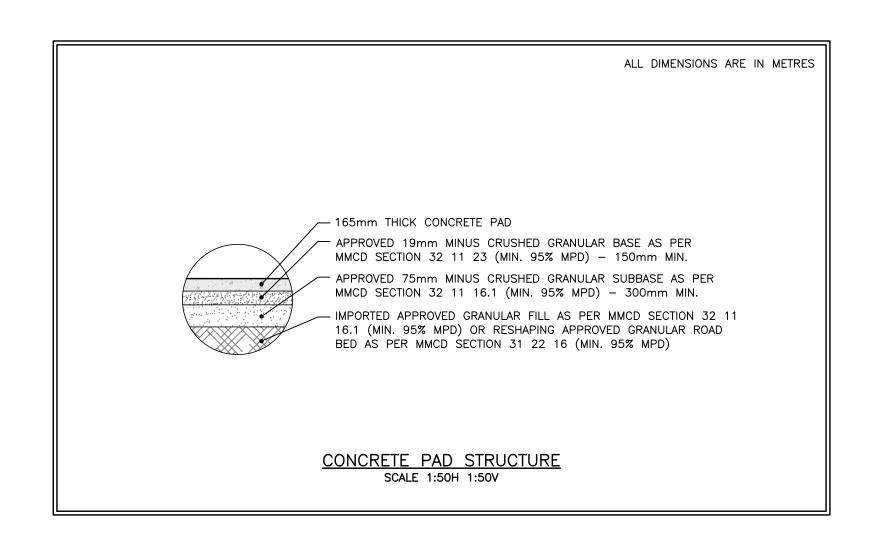
TYPICAL CROSS-SECTIONS LOT 2A & 2B 1400, 1450 MOUNT FEE ROAD


hor: 1:100 vert: 1:100 4002 drawing no. (BP) TYP-1




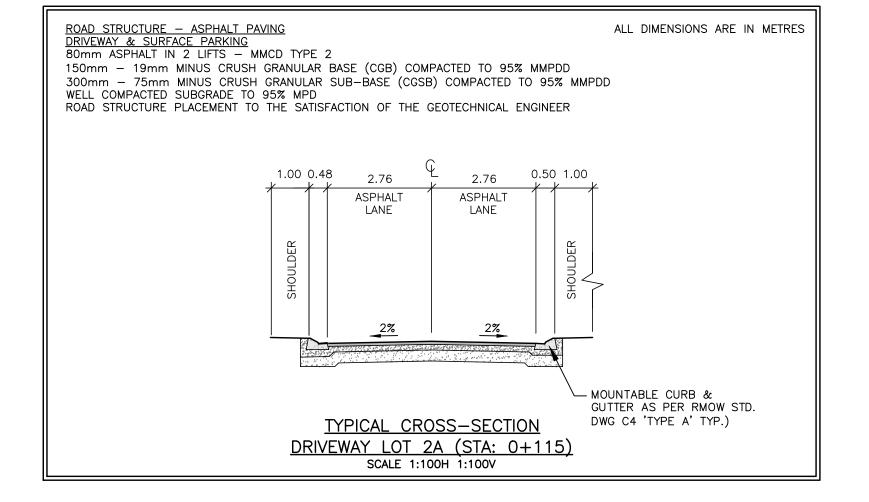


EGBC PERMIT No. 1001444

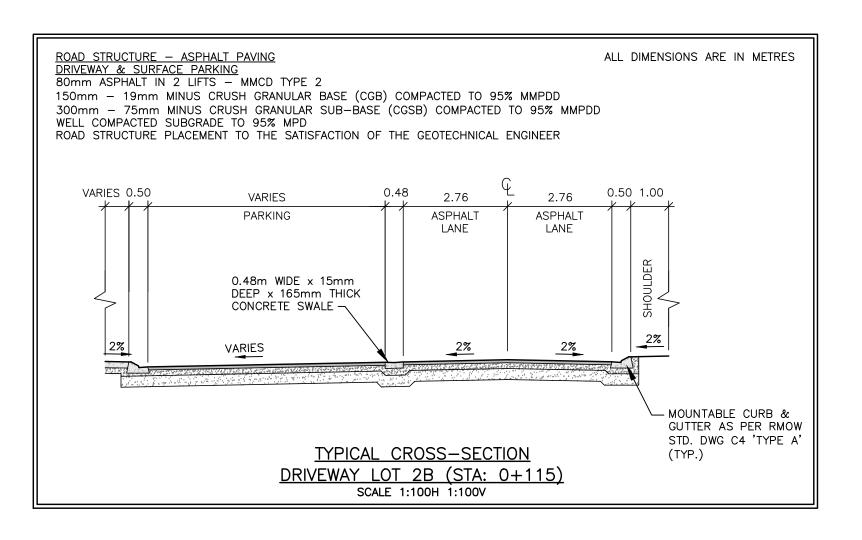

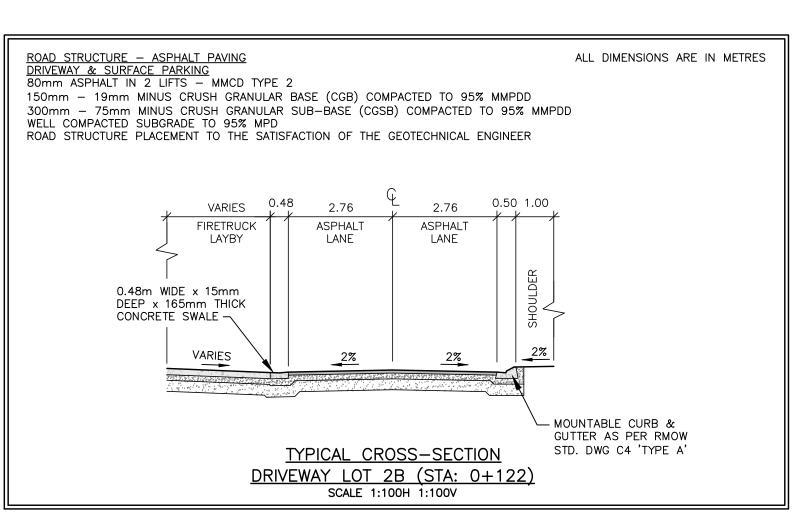

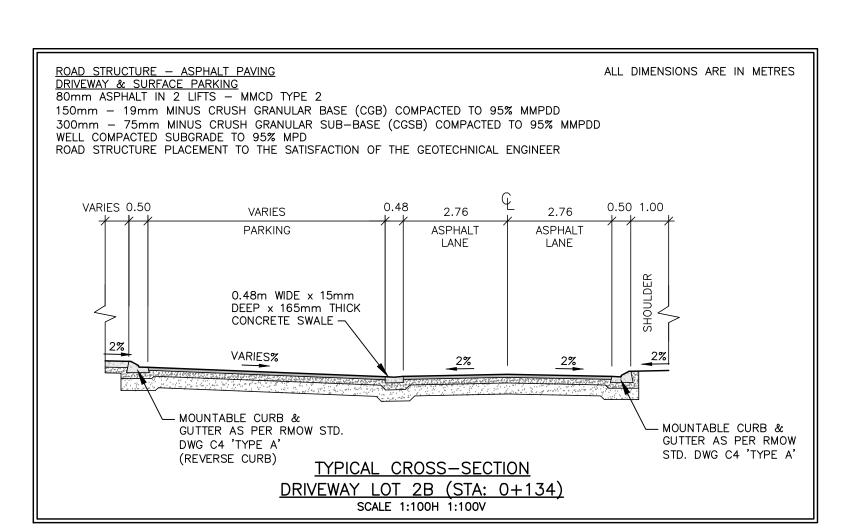

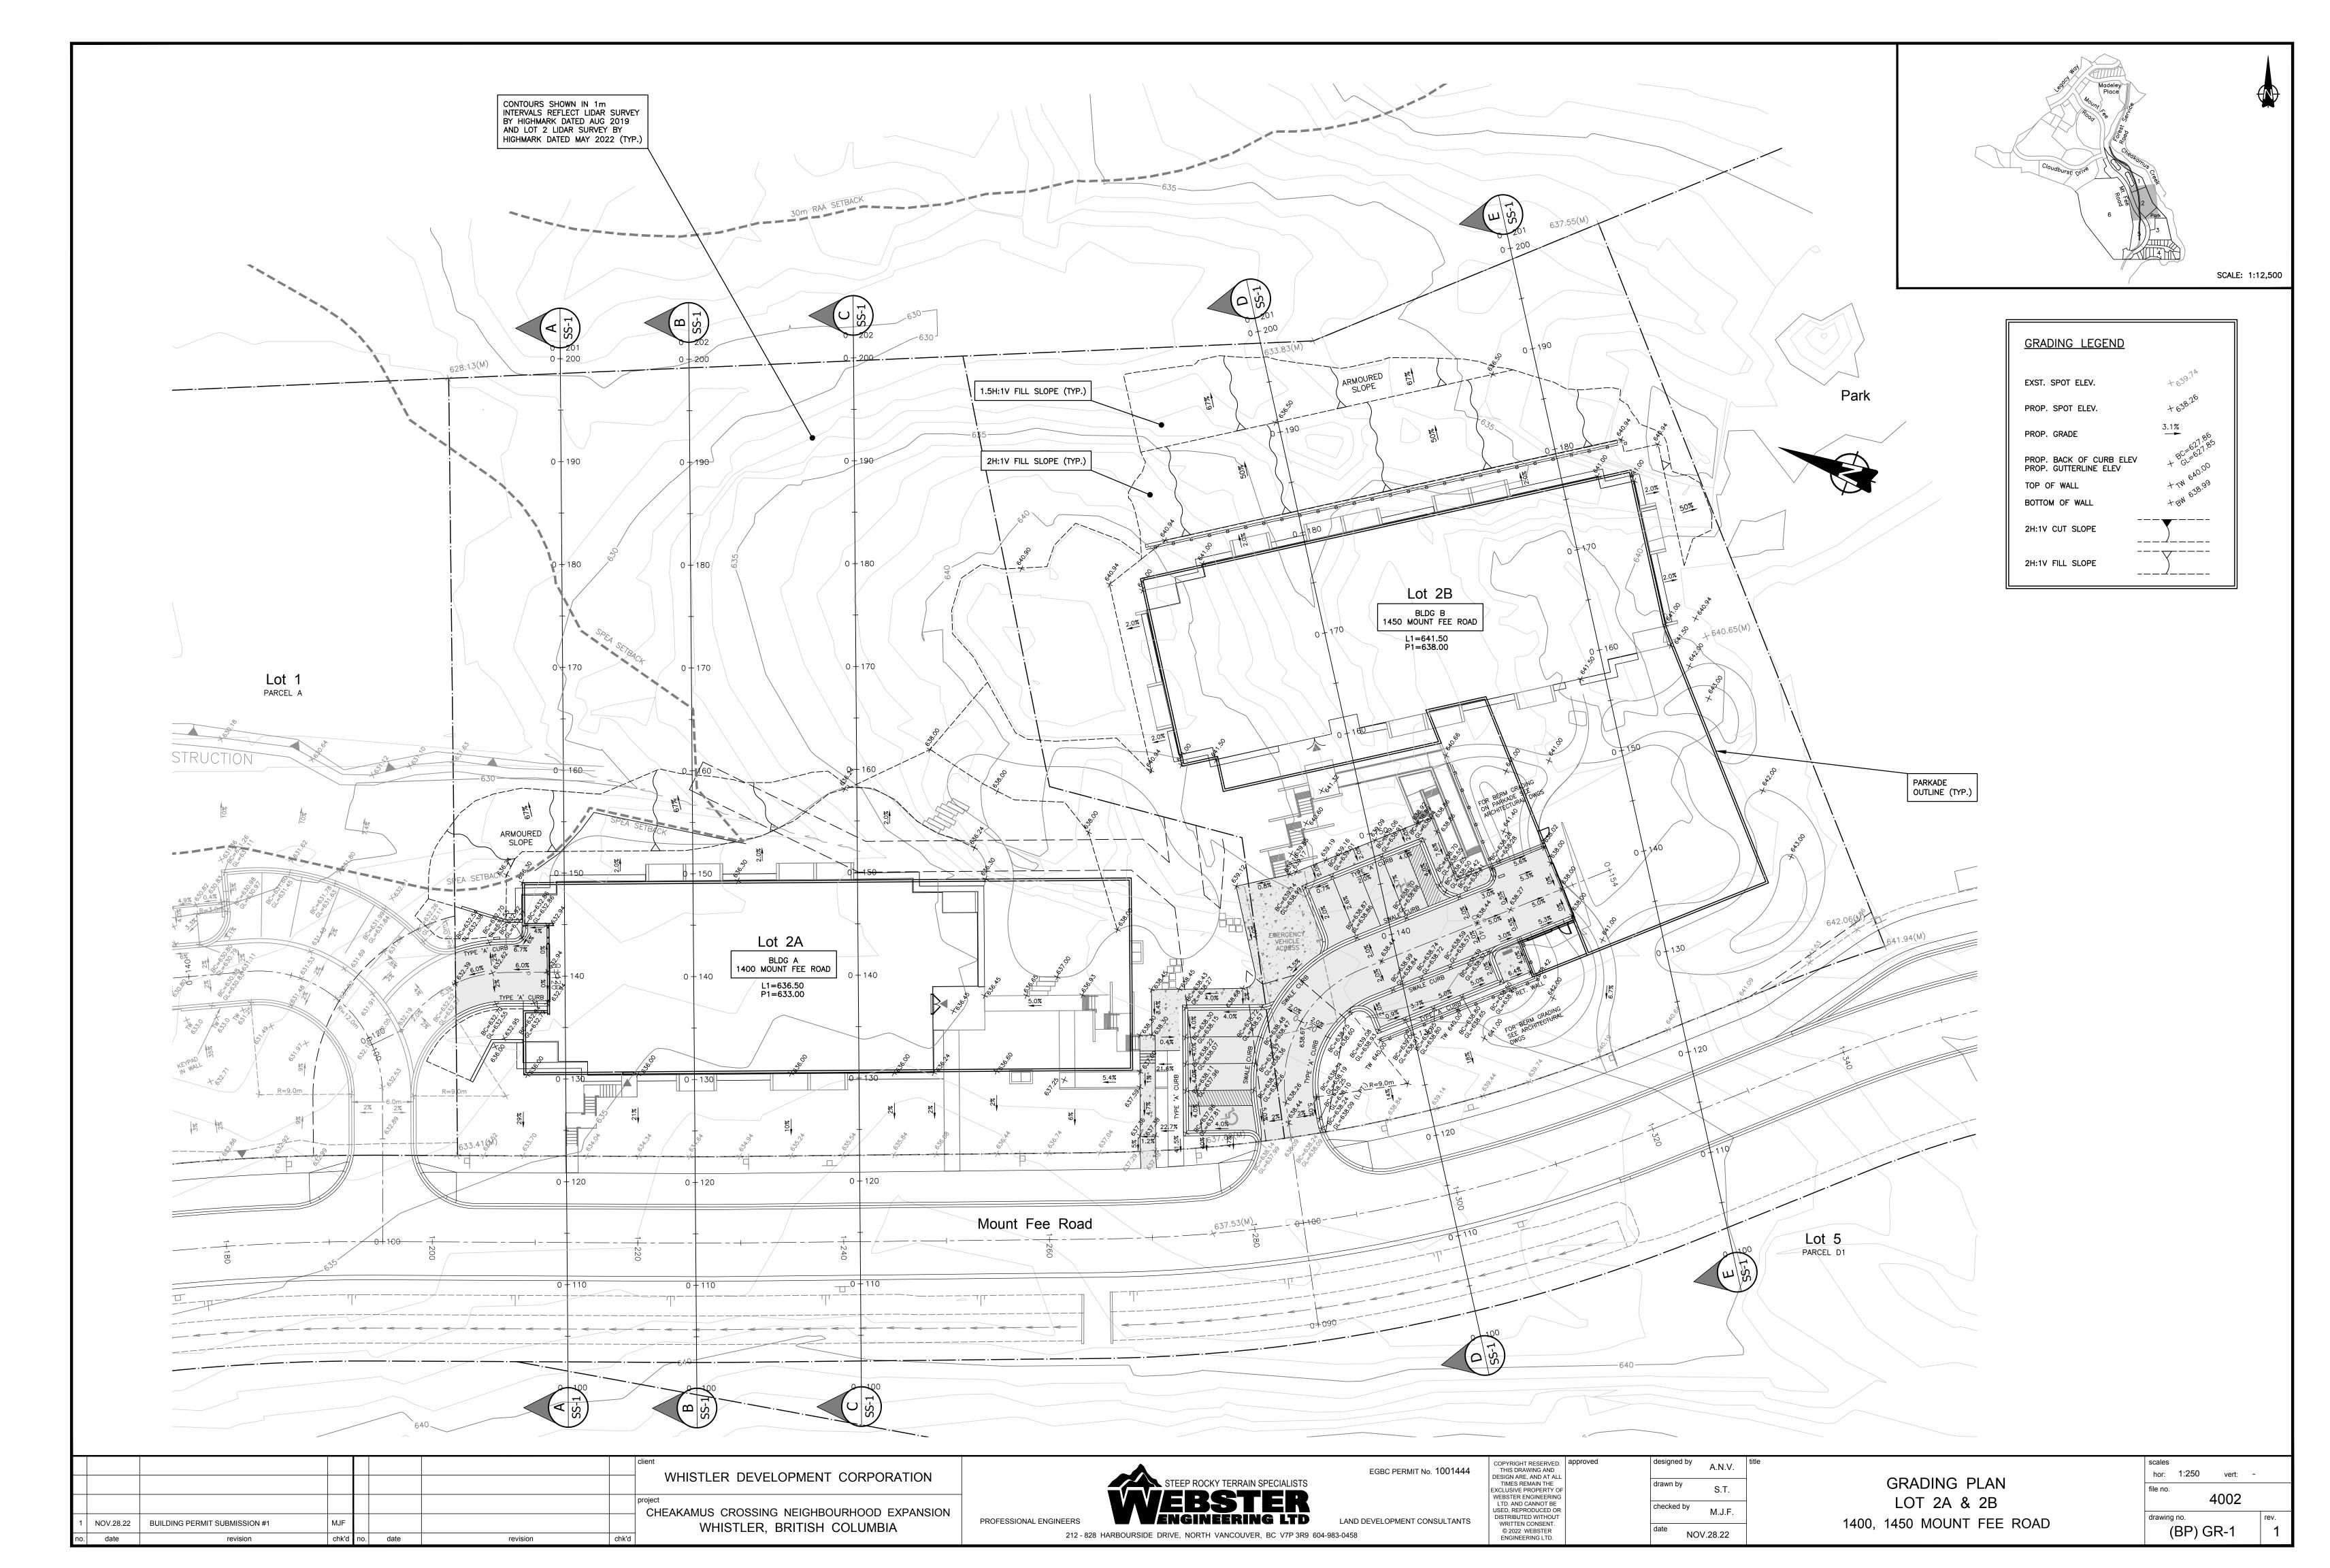

Site-Section C-C 620 0+200 0+120 0+180 0+130 LOT 2A BLDG A 1400 MOUNT FEE RD __FG=636.30 1.5H:1V

ARMOURED

SLOPE (TYP.) __FG=636.00 L1=636.50 635 U/S PERIM. FOOTINGS=632.40

U/S PAD FOOTINGS=631.96

U/S ELEV. PIT SLAB=631.48 Site-Section B-B 620 0+200 0+120 0+180 LOT 2A BLDG A 1400 MOUNT FEE RD FINAL GRD.
ON-SITE (TYP.) __FG=636.30 FORMER FOREST
— SERVICE ROAD (TYP.) L1=636.50 __FG=632.32 EXST. GRD. —/ (TYP.) FINAL GRD. U/S PERIM. FOOTINGS=632.40

U/S PAD FOOTINGS=631.96

U/S ELEV. PIT SLAB=631.48 OFF-SITE (TYP.) -Site-Section A-A 620 0+200 0+120 0+130 0+150 0+160 0+180 0+190 COPYRIGHT RESERVED.
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ENGINEERING LTD. hor: 1:250 vert: 1:250 WHISTLER DEVELOPMENT CORPORATION SITE-SECTIONS 4002 LOT 2A checked by CHEAKAMUS CROSSING NEIGHBOURHOOD EXPANSION J.A.T. **VENGINEERING LTD** LAND DEVELOPMENT CONSULTANTS PROFESSIONAL ENGINEERS 1400 MOUNT FEE ROAD WHISTLER, BRITISH COLUMBIA NOV.28.22 BUILDING PERMIT SUBMISSION #1 (BP) SS-1 NOV.28.22 212 - 828 HARBOURSIDE DRIVE, NORTH VANCOUVER, B.C. V7P 3R9 604-983-0458 revision chk'd

LOT 2A

BLDG A 1400 MOUNT FEE RD


L1=636.50


P1=633.00


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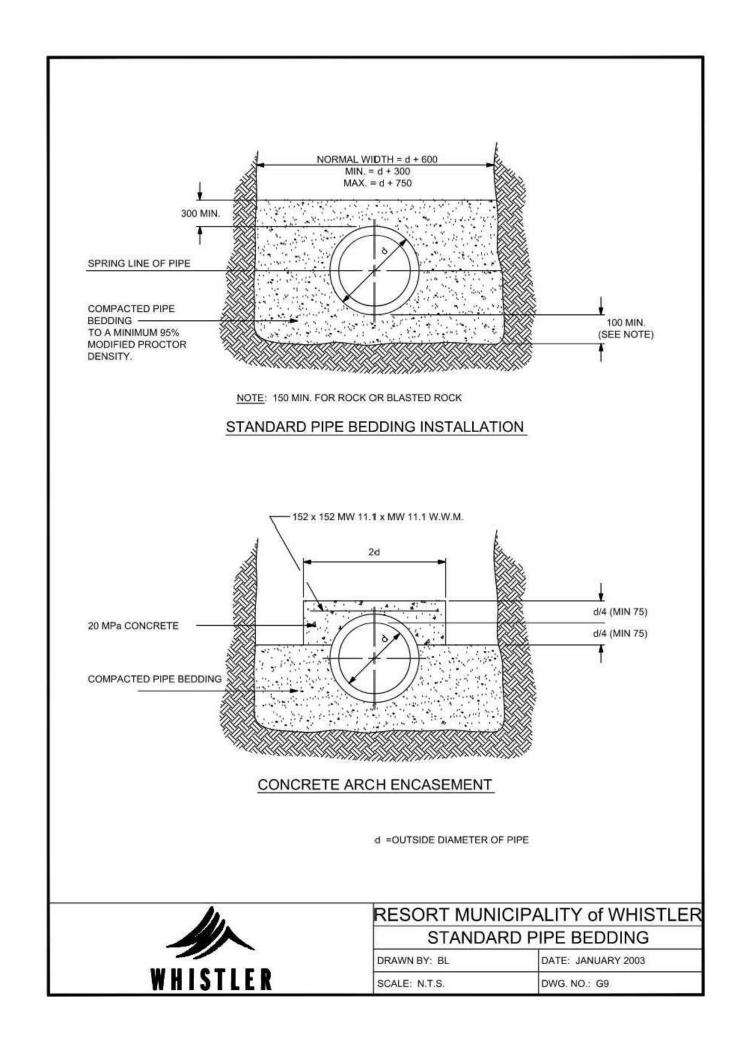
└─U/S PERIM. FOOTINGS=632.40


U/S PAD FOOTINGS=631.96 U/S ELEV. PIT SLAB=631.48




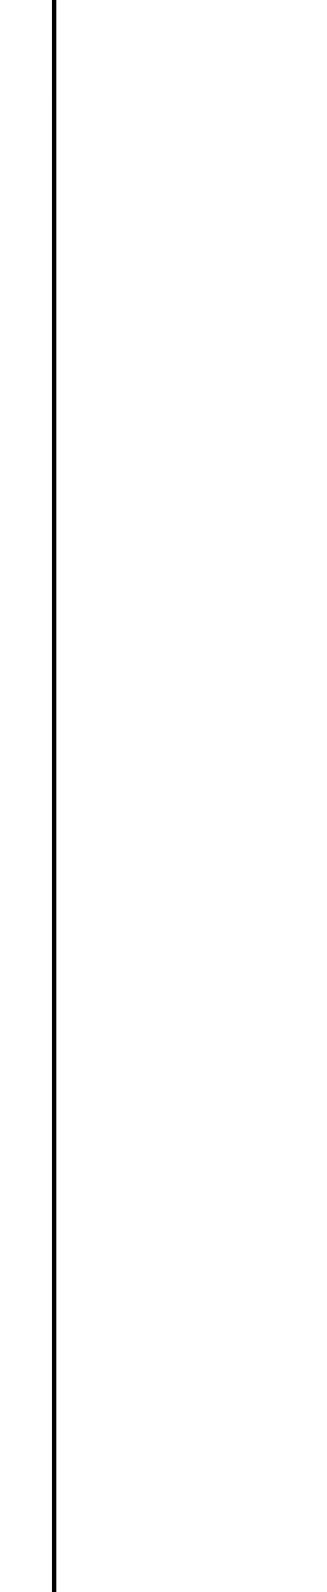


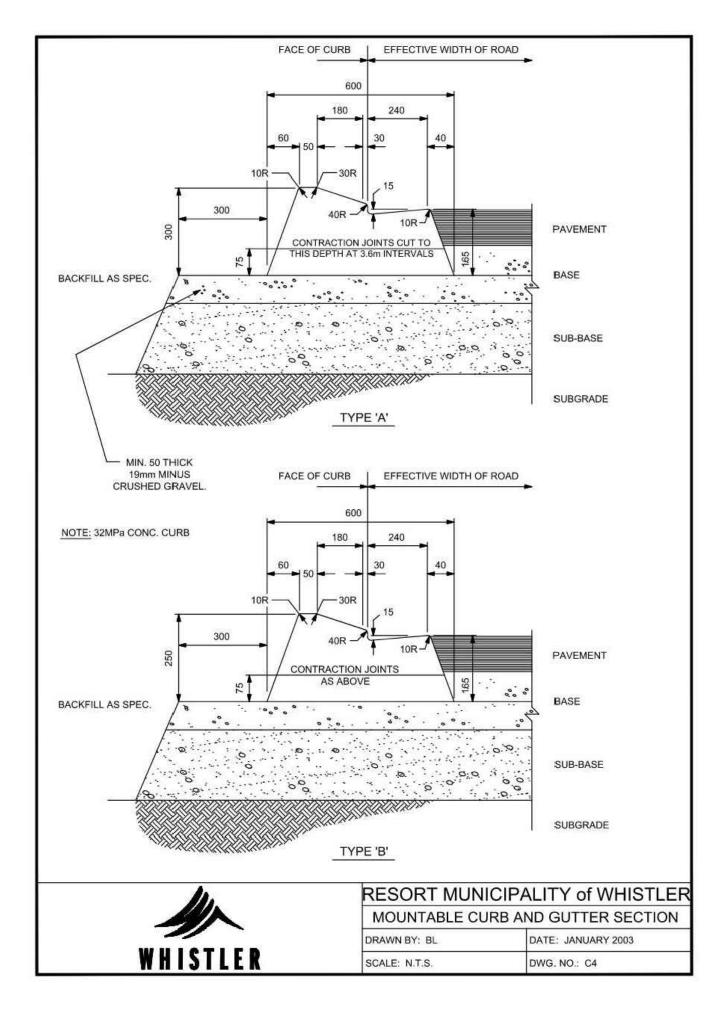


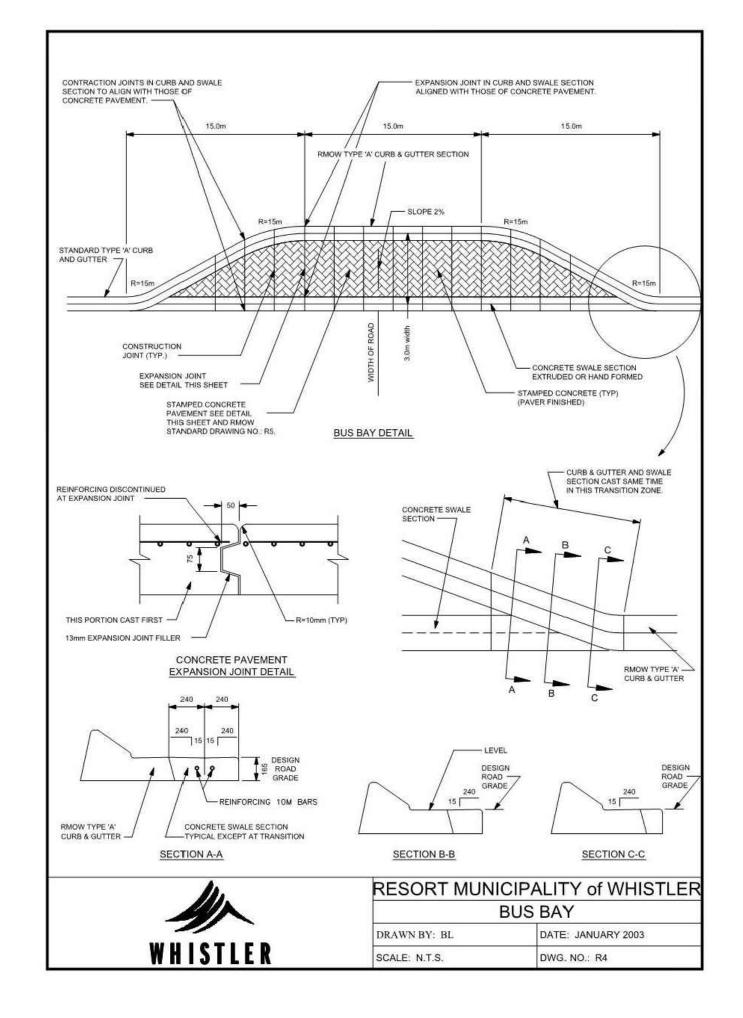


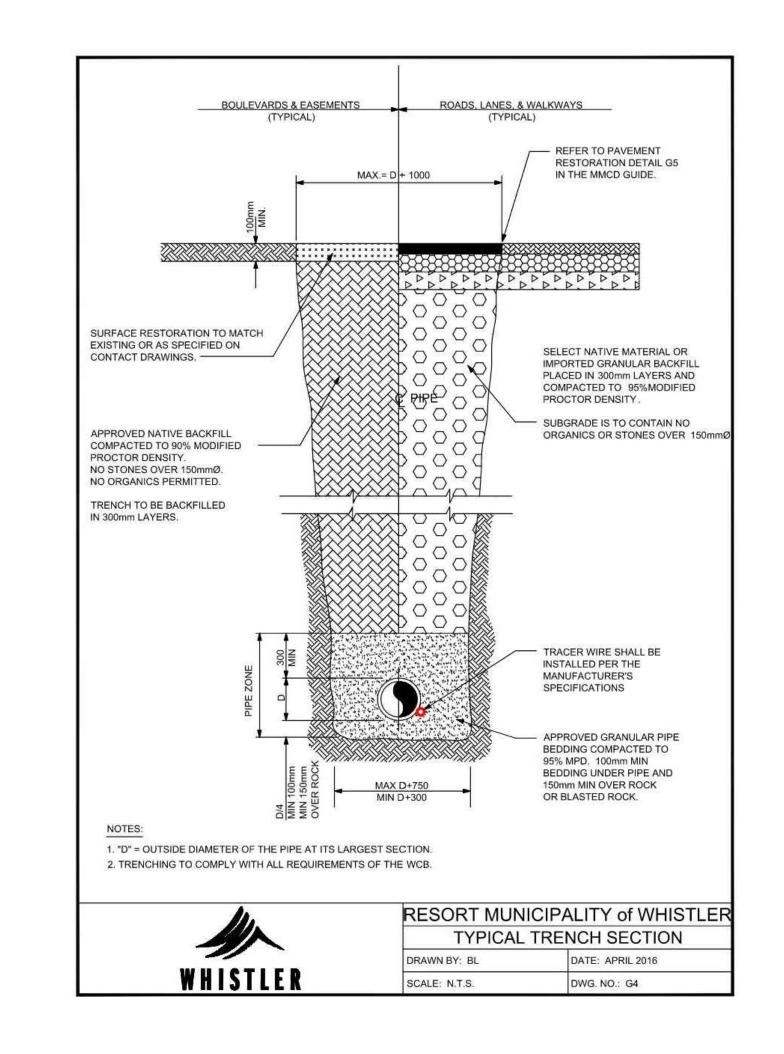

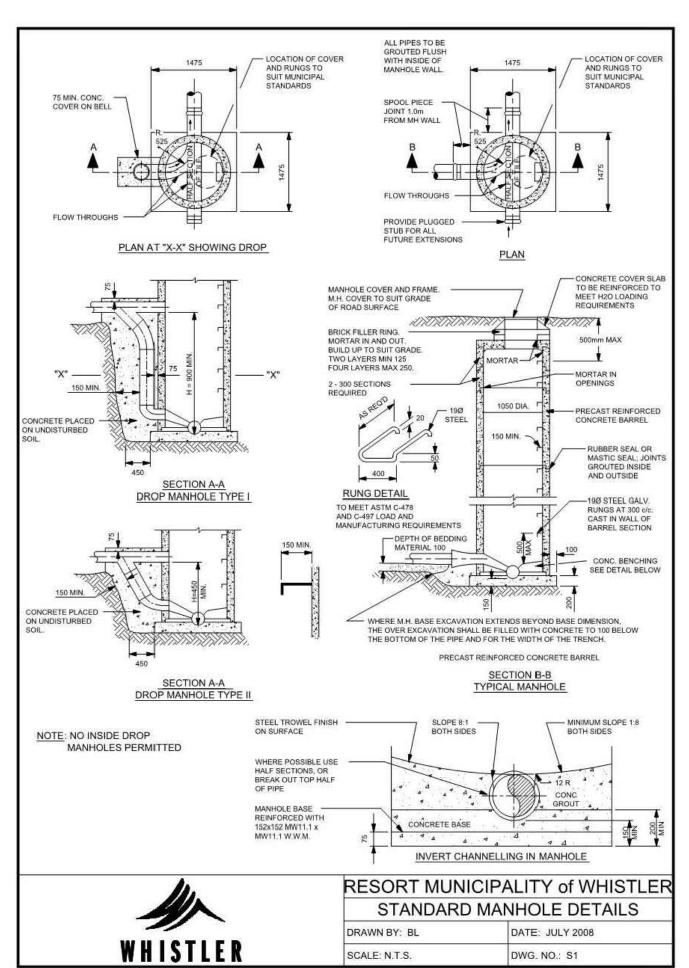

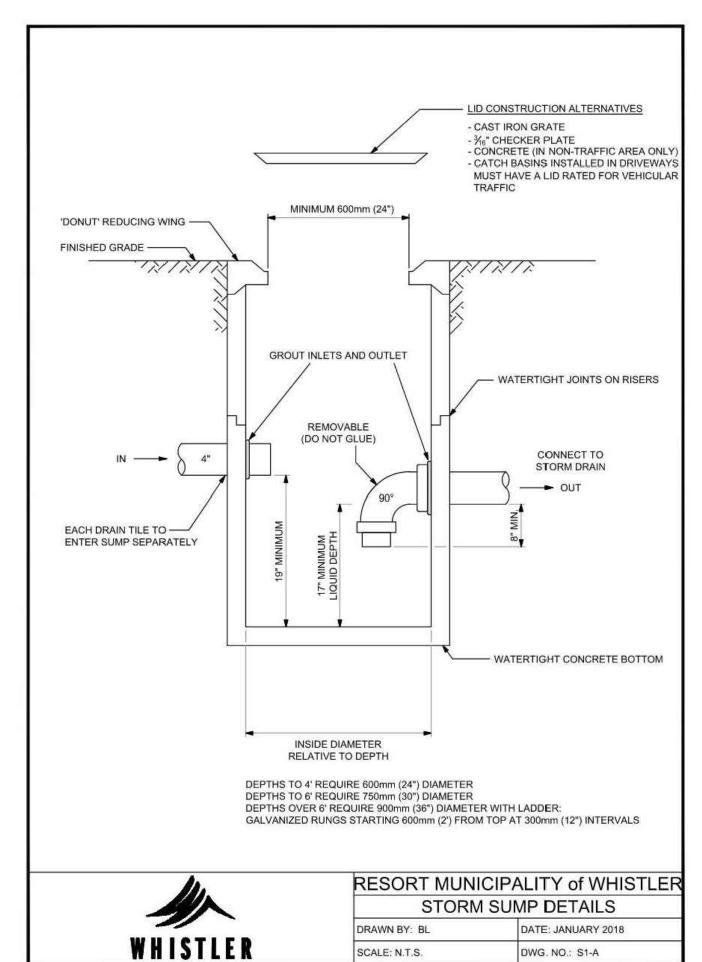

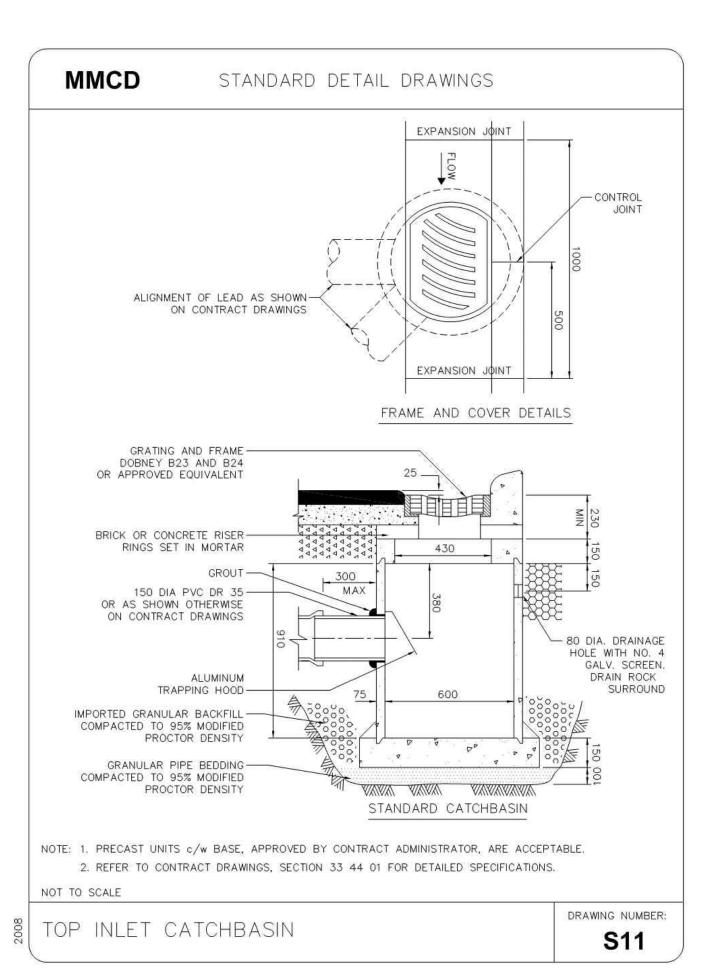

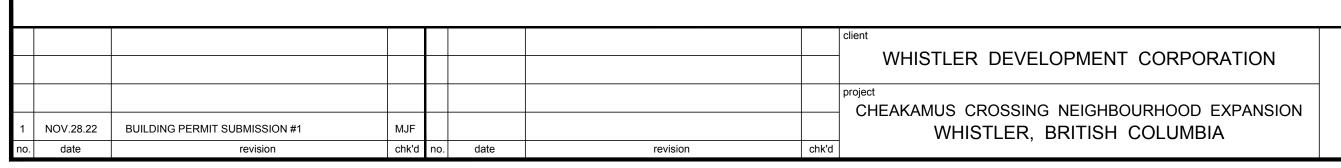



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designed by A.N.V.

drawn by S.T.

checked by M.J.F.

date NOV.28.22

STANDARD DETAILS

LOT 2A & 2B

1400, 1450 MOUNT FEE ROAD

scales
hor: 1:100 vert: 1:100
file no.

4002
drawing no.
(BP) DET-1

1